

MIDWEST CITY POLICE DEPARTMENT RESTROOM RENOVATION 100 NORTH MIDWEST BLVD MIDWEST CITY, OKLAHOMA 73110

SHEET NUMBER SHEET NAME

CS G001 G002 COVER SHEET GENERAL INFORMATION AND CODE ANALYSIS ACCESSIBILITY REQUIREMENTS

ARCHITECTURAL A151 CH TOILET NW FIRST FLOOR A152 PD TOILET FIRST FLOOR A153 PD TOILET SECOND FLOOR A154 EXISTING BASEMENT LEVEL PLUMBING A601 SCHEDULES AND MILLWORK MECHANICAL, ELECTRICAL, PLUMBING NOTES AND SCHEDULES A602



505 ARCHITECTS LLC 1631 S DELAWARE AVENUE TULSA, OK 74104 918.605.5303 WWW.505ARCHITECTS.COM



GREEN ACORN LLC 1820 S BOULDER AVENUE, SUITE 300 TULSA, OKLAHOMA 74119 918.629.4291 WWW.GREENACORNLLC.COM





1:


ð 금

Č Ū

12.2	0	23016
ISSUE D	ISSUE	PROJECT NO.
l	I	




TOILET NW 1ST FLOOR

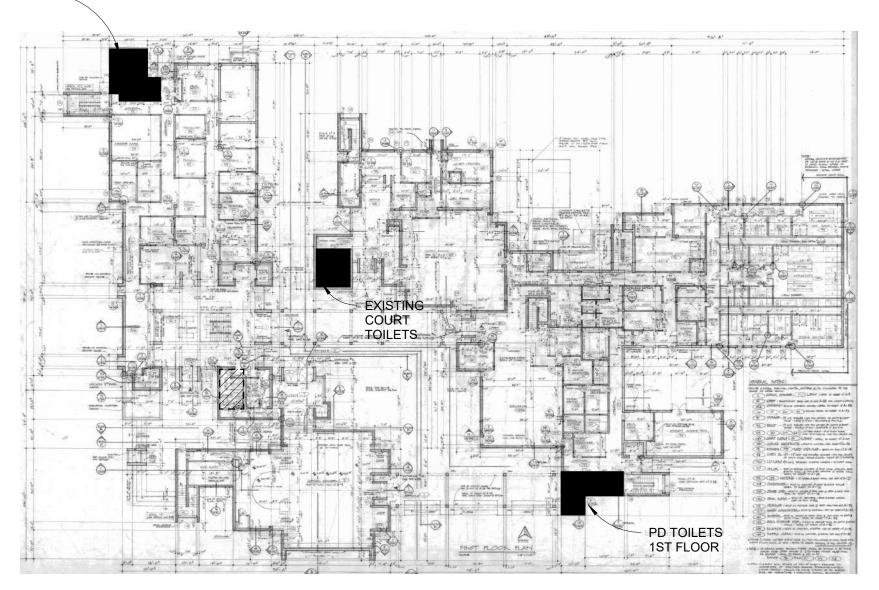




OVERALL FLOOR PLAN - 1ST FLOOR

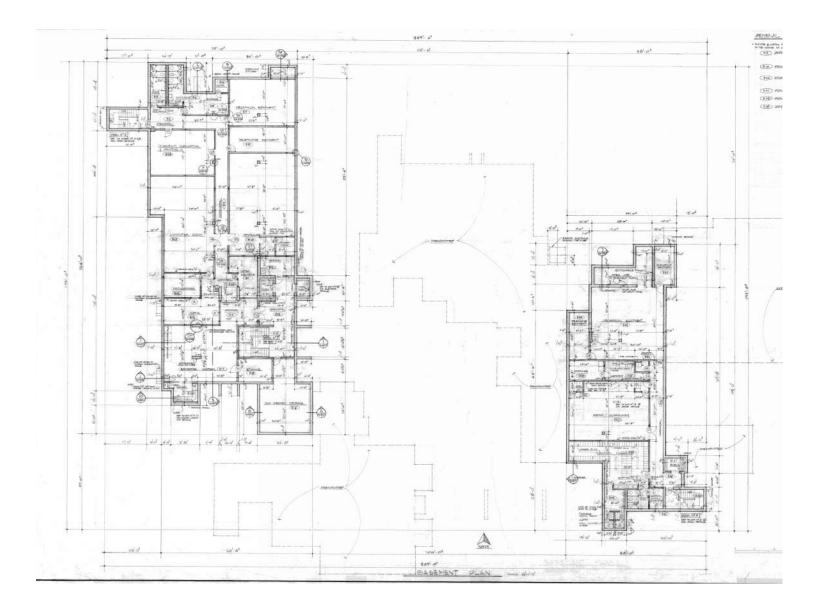




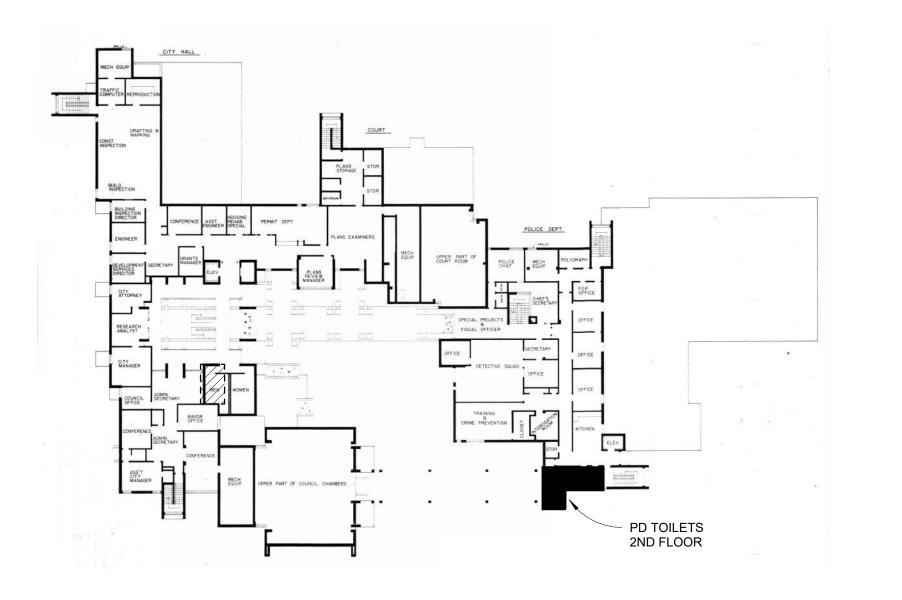


5

OVERALL FLOOR PLAN - 2ND FLOOR 1" = 40'-0"

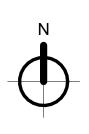



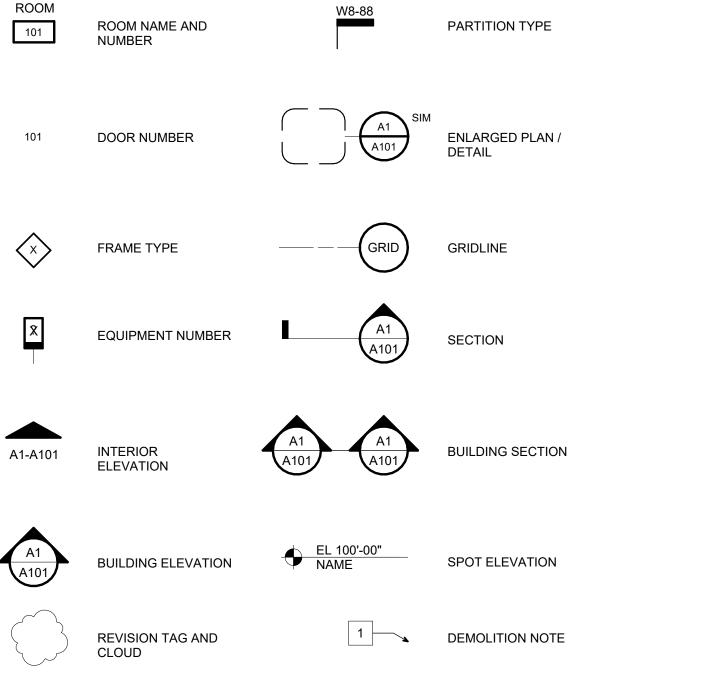

SYMBOLS N.T.S.



PERFORM WORK IN COMPLIANCE WITH ALL APPLICABLE ACCESSIBILITY, FEDERAL, STATE AND LOCAL CODES AND ORDINANCES. NOTIFY ARCHITECT OF ANY DISCREPANCIES FOR CLARIFICATION.

2. REFER TO SPECIFICATIONS FOR MATERIALS AND STANDARDS OF CONSTRUCTION.

3. COORDINATE WITH ALL TRADES PRIOR TO CONSTRUCTION TO ENSURE PROPER SEQUENCING OF THE WORK.

4. VERIFY ALL EXISTING CONDITIONS PRIOR TO BIDDING, FABRICATION AND CONSTRUCTION. NOTIFY ARCHITECT OF ANY DISCREPANCIES FOR CLARIFICATION.

5. DO NOT SCALE DRAWINGS. NOTIFY ARCHITECT OF ANY DIMENSIONAL DISCREPANCIES FOR CLARIFICATION.

6. DIMENSIONS UNLESS NOTED OTHERWISE: TO FACE OF CONCRETE OF MASONRY WORK; TO CENTERLINE OF COLUMNS OR OTHER GRID POINT; TO CENTERLINE OF PARTITIONS AND FRAMED WINDOW AND DOOR OPENINGS; TO FINISH FACES OF CLEAR WIDTHS.

7. VERIFY SIZE, CHARACTERISTICS, AND REQUIRED CLEARANCES OF ALL EQUIPMENT TO BE FURNISHED WITH MANUFACTURERS OR SUPPLIERS PRIOR TO CONSTRUCTION. NOTIFY ARCHITECT OF ANY DISCREPANCIES FOR CLARIFICATION.

8. PROVIDE BLOCKING AND GROUNDS AS SPECIFIED FOR BUILT-IN AND SURFACE MOUNTED ITEMS PRIOR TO APPLYING WALL SURFACING MATERIALS.

9. CONCEAL ALL PLUMBING, DUCTWORK, CONDUIT, WIRE, AND SIMILAR ITEMS UNLESS NOTED OTHERWISE.

10. INSTALL ALL MATERIALS, SYSTEMS, AND COMPONENTS PER MANUFACTURER'S RECOMMENDATIONS AND REQUIREMENTS FOR A FULLY WARRANTED INSTALLATION.

11. PROVIDE PLUMBING FIXTURES AS INDICATED. CONNECT TO EXISTING SANITARY SEWER AND EXISTING DOMESTIC WATER SUPPLY LINES.

12. PLUMBING INSTALLATION SHALL COMPLY WITH CURRENT ADOPTED INTERNATIONAL PLUMBING CODE.


13. CLEAN FAUCET AERATORS AND PIPE STRAINERS PRIOR TO TURNING COMPLETED PROJECT OVER TO OWNER.

14. CAULK AROUND ALL FIXTURES TO SEAL BETWEEN FIXTURE AND FLOOR OR WALL.

15. PROVIDE ALL ACCESSORIES REQUIRED FOR FUNCTIONAL ELECTRICAL INSTALLATION AND SUPPORT.

16. PROVIDE DRYWALL / PLASTER KIT FOR FIXTURES MOUNTED IN GYPSUM BOARD CEILING

GENERAL NOTES N.T.S.

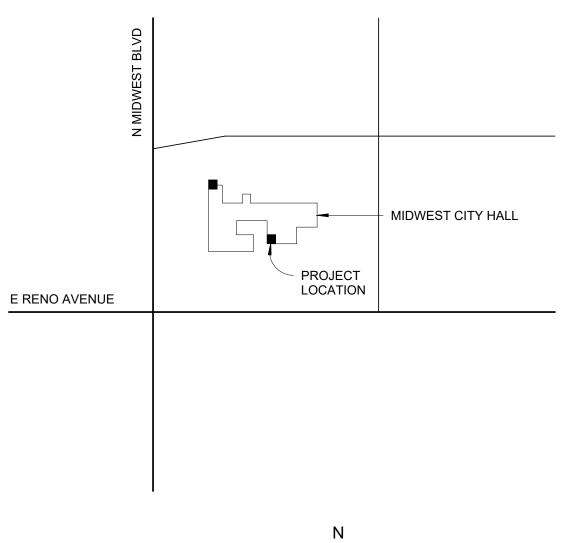





1631 S DELAWARE AVENUE TULSA, OKLAHOMA 74104 918.605.5303

WWW.505ARCHITECTS.COM

NUMBER ISSUE DATE

REVISION



MIDWEST CITY POLICE DEPARTMENT RESTROOM RENOVATION

100 NORTH MIDWEST BLVD MIDWEST CITY, OKLAHOMA 73110

ISSUE **01**

ISSUE DATE 12.29.2023

PROJECT NO. **23016**

DRAWN BY


CHECKED BY BT


SHEET TITLE INFORMATION AND CODE ANALYSIS










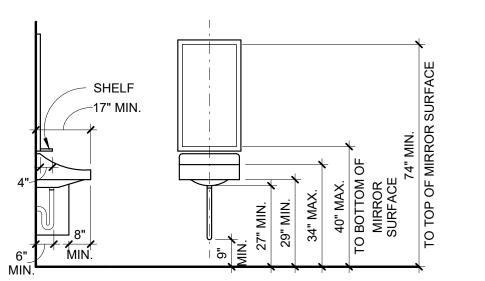

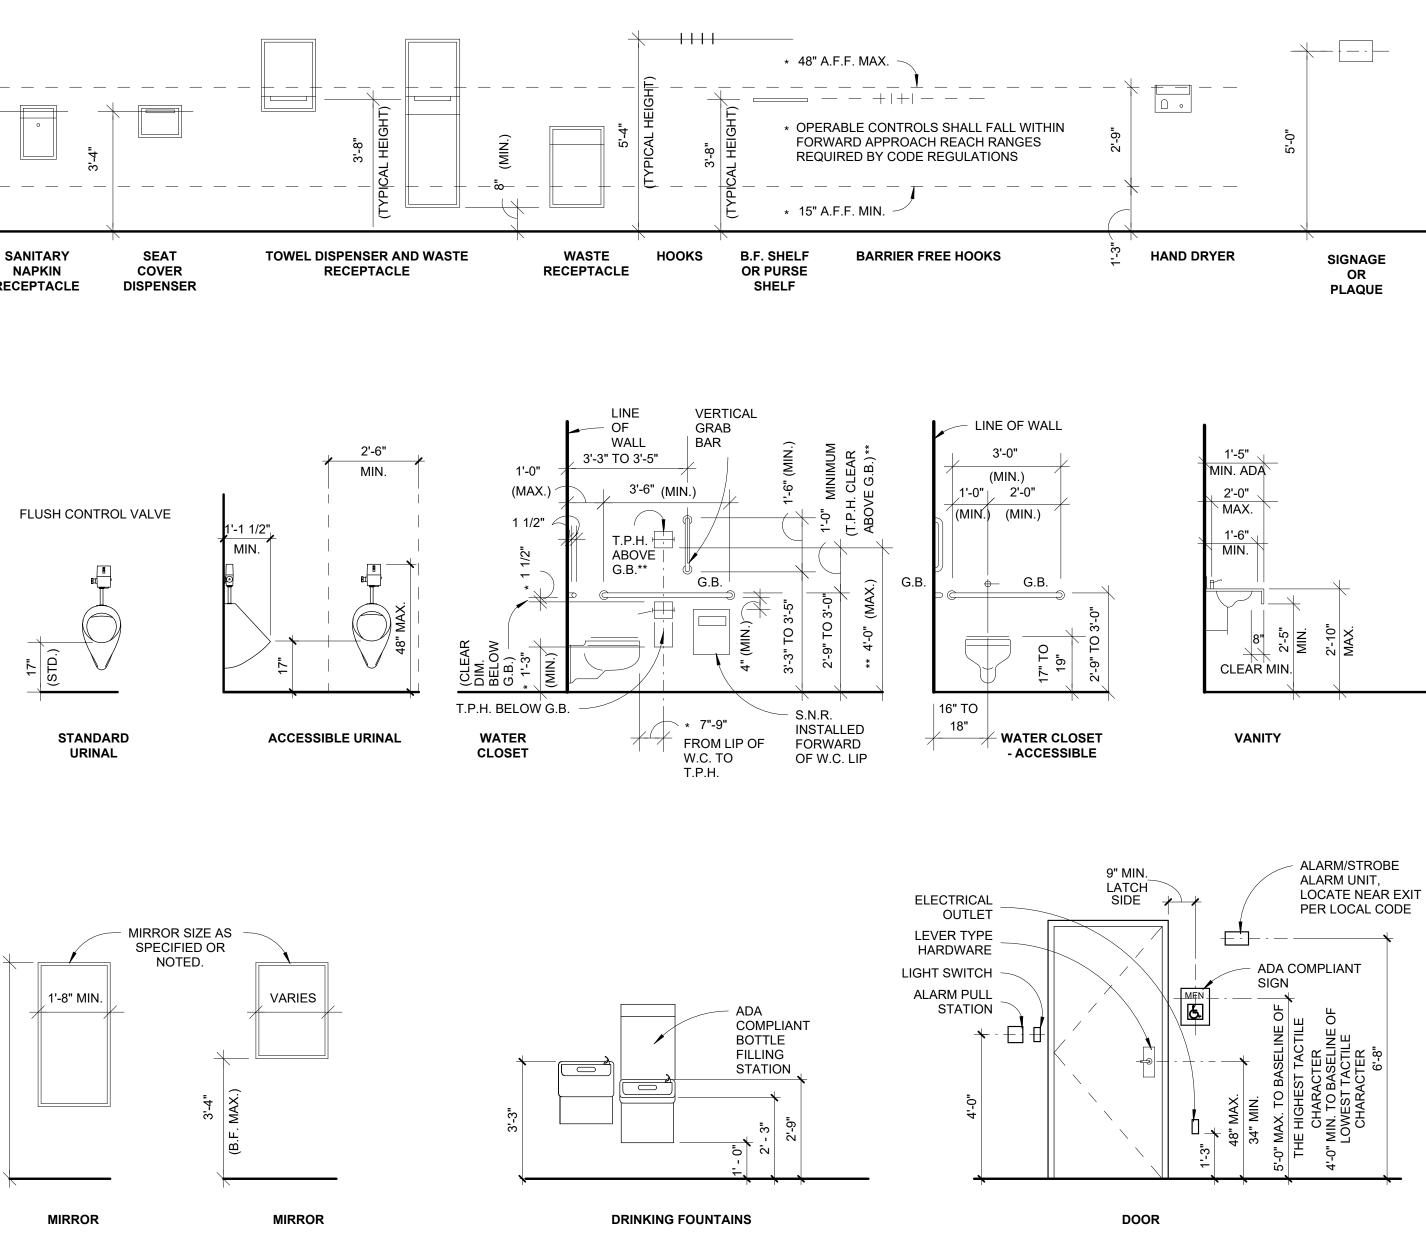

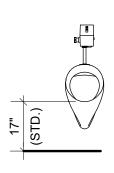

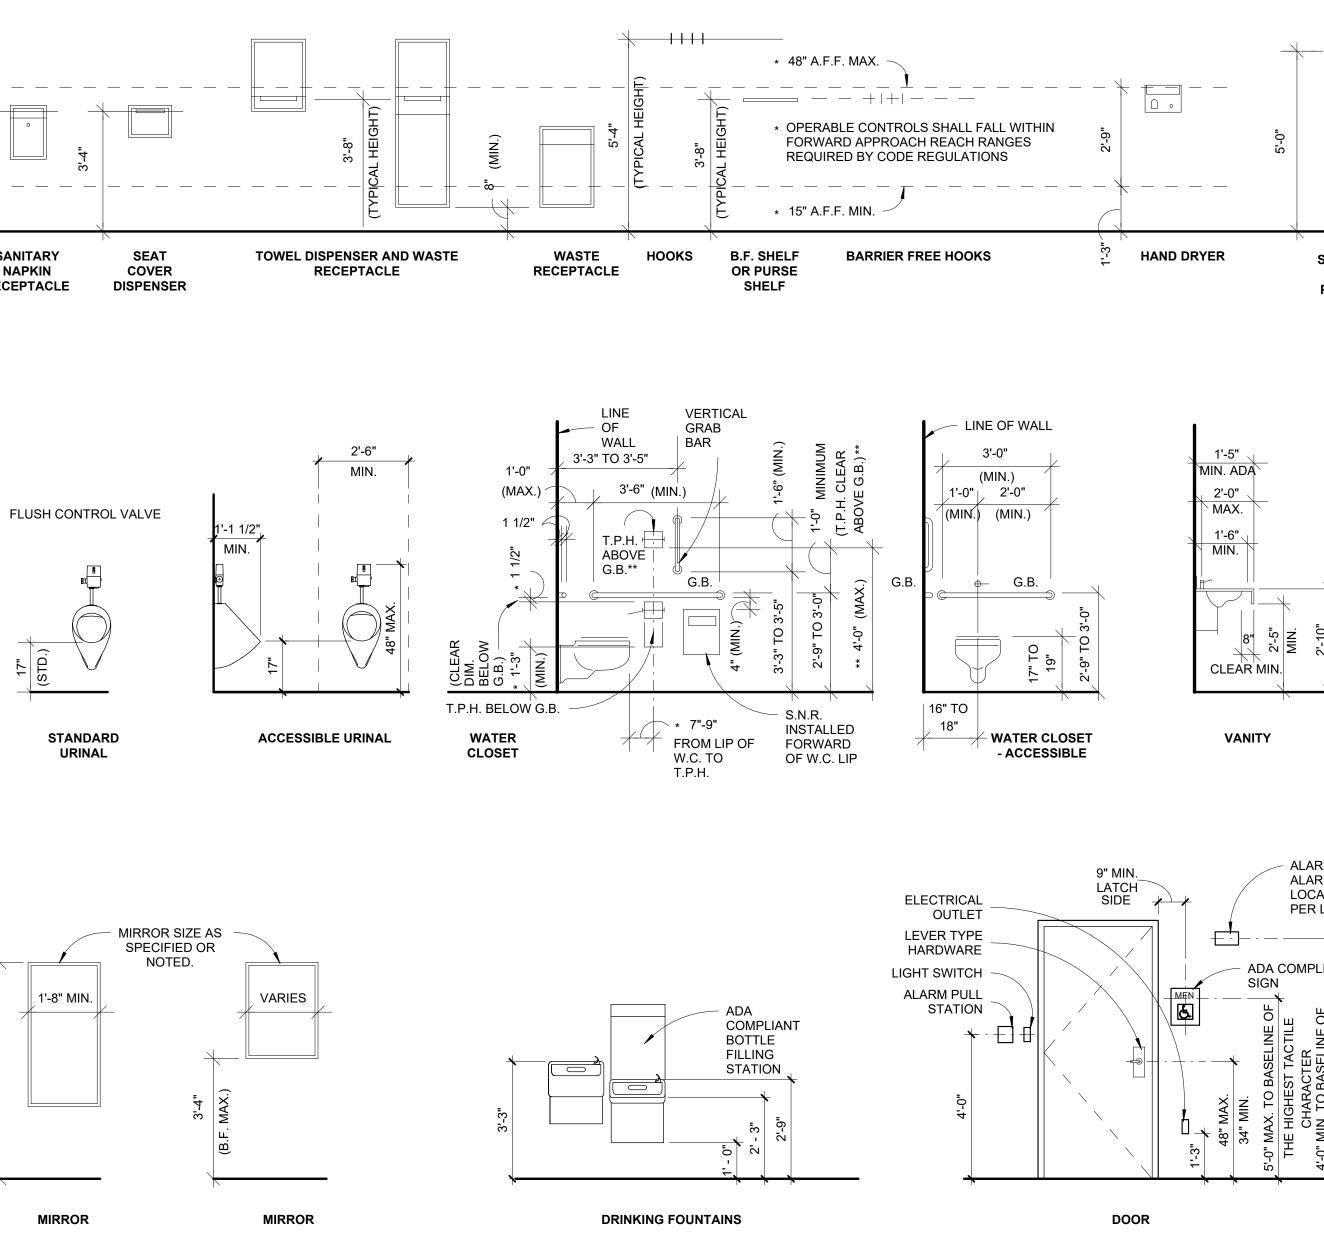

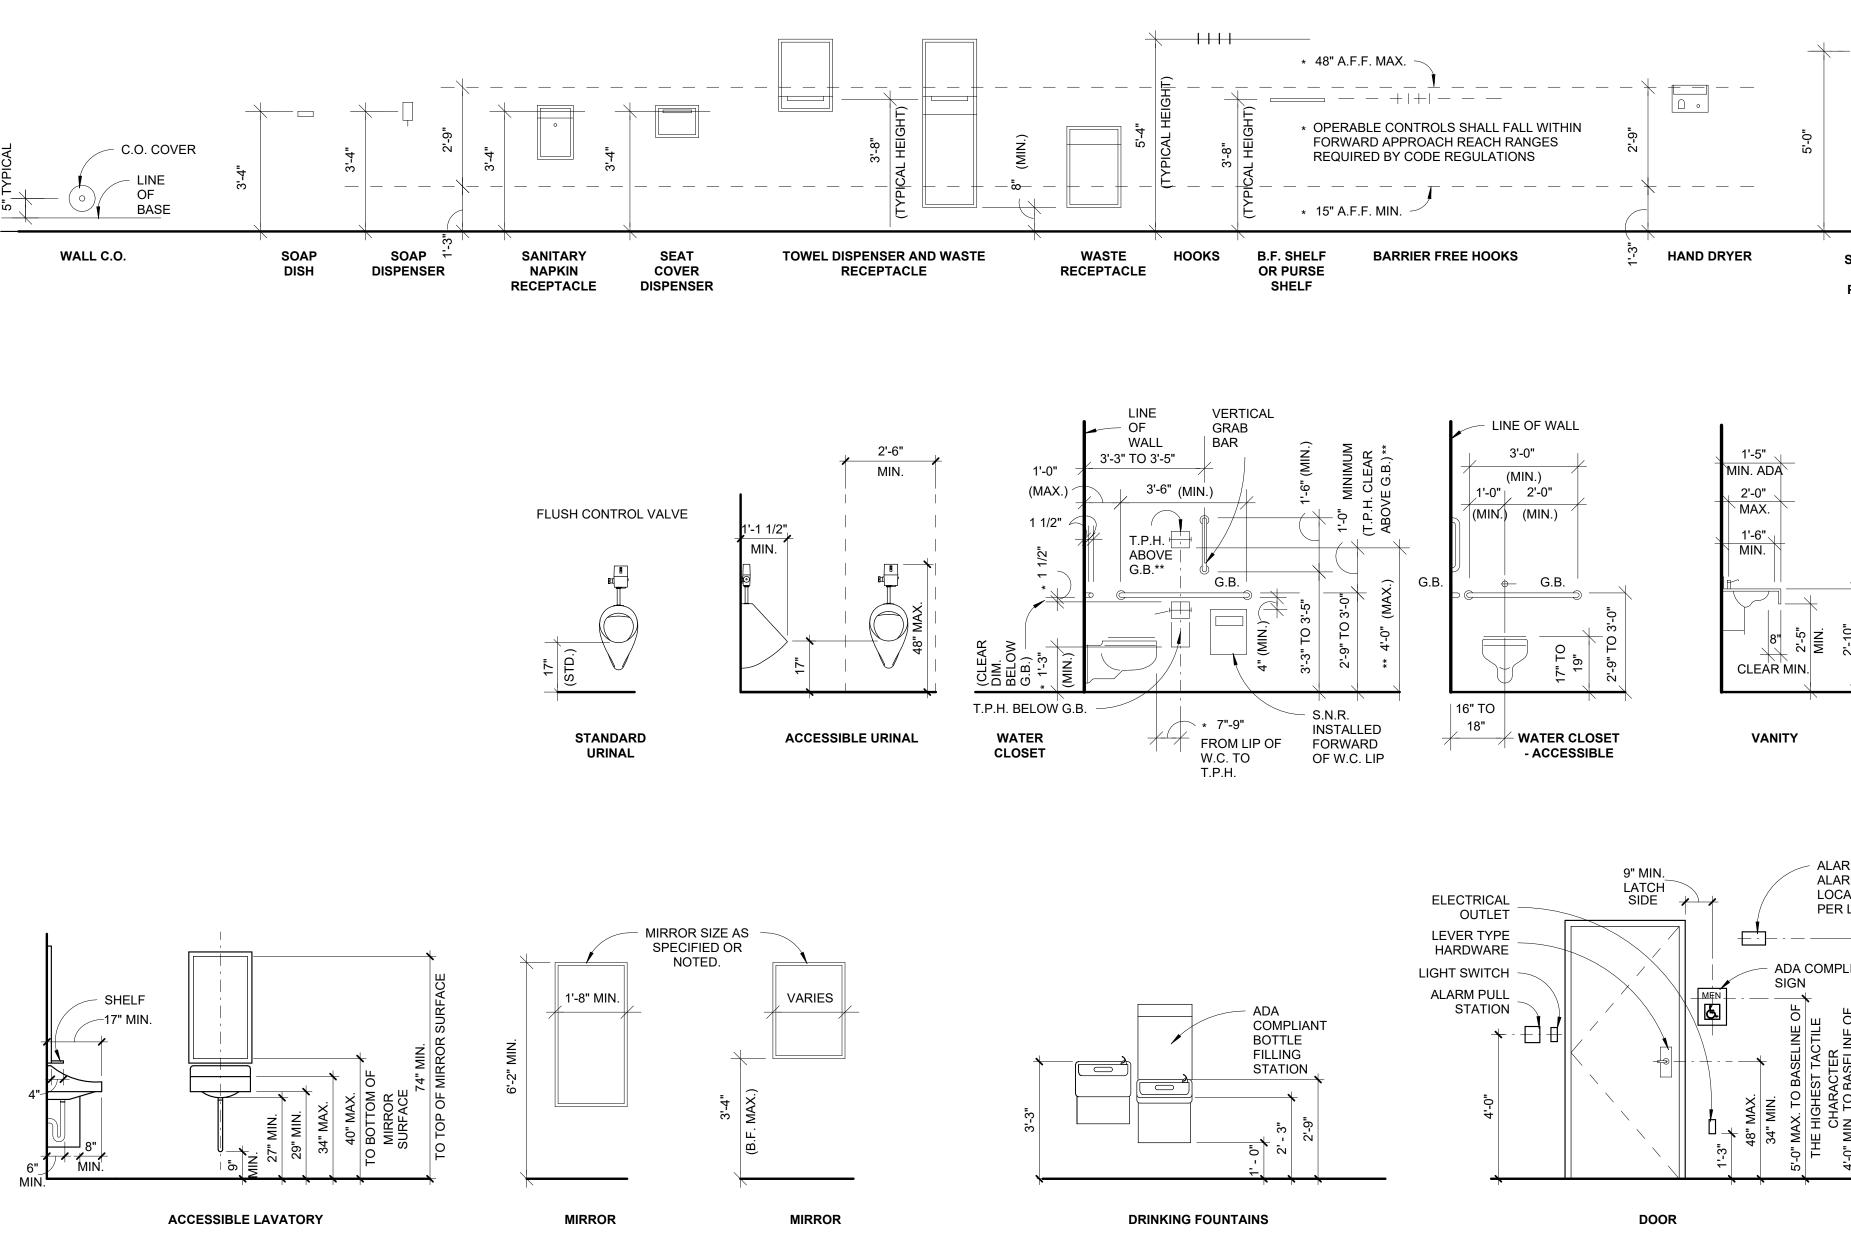


ALL MANUALLY OPERATED FIXTURES TO BE LEVER TYPE CONTROL. GRAB BAR AND SEAT SHALL WITHSTAND A LOAD OF NOT LESS THAN 250 POUNDS APPLIED AT ANY POINT. PROVIDE 1 1/2" CLEARANCE BETWEEN GRAB BAR AND WALL.

HOT WATER AND DRAIN PIPES UNDER LAVATORY SHALL BE INSULATED OR OTHERWISE CONFIGURED TO PROTECT AGAINST CONTACT. PROVIDE 30" WIDE FRONT-IN CLEARANCE FOR WHEELCHAIR ACCESS AT SINK AND URINAL.

ALL SIGNAGE SHALL COMPLY WITH ADA AND TAS. ADJUST ALL DOOR CLOSERS TO A MAXIMUM OF 5 LBS OF FORCE.

ACCESSIBLE TOILET COMPARTMENTS TO HAVE A SELF CLOSING DOOR.

SIGNAGE OR PLAQUE

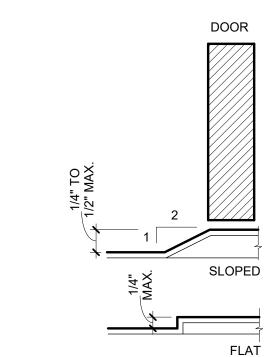

THRESHOLD



1631 S DELAWARE AVENUE TULSA, OKLAHOMA 74104 918.605.5303

WWW.505ARCHITECTS.COM

NUMBER ISSUE DATE REVISION



MIDWEST CITY POLICE DEPARTMENT RESTROOM RENOVATION

100 NORTH MIDWEST BLVD MIDWEST CITY, OKLAHOMA 73110

ISSUE **01**

ISSUE DATE 12.29.2023

PROJECT NO. **23016**


DRAWN BY


CHECKED BY BT

SHEET TITLE REQUIREMENTS



02

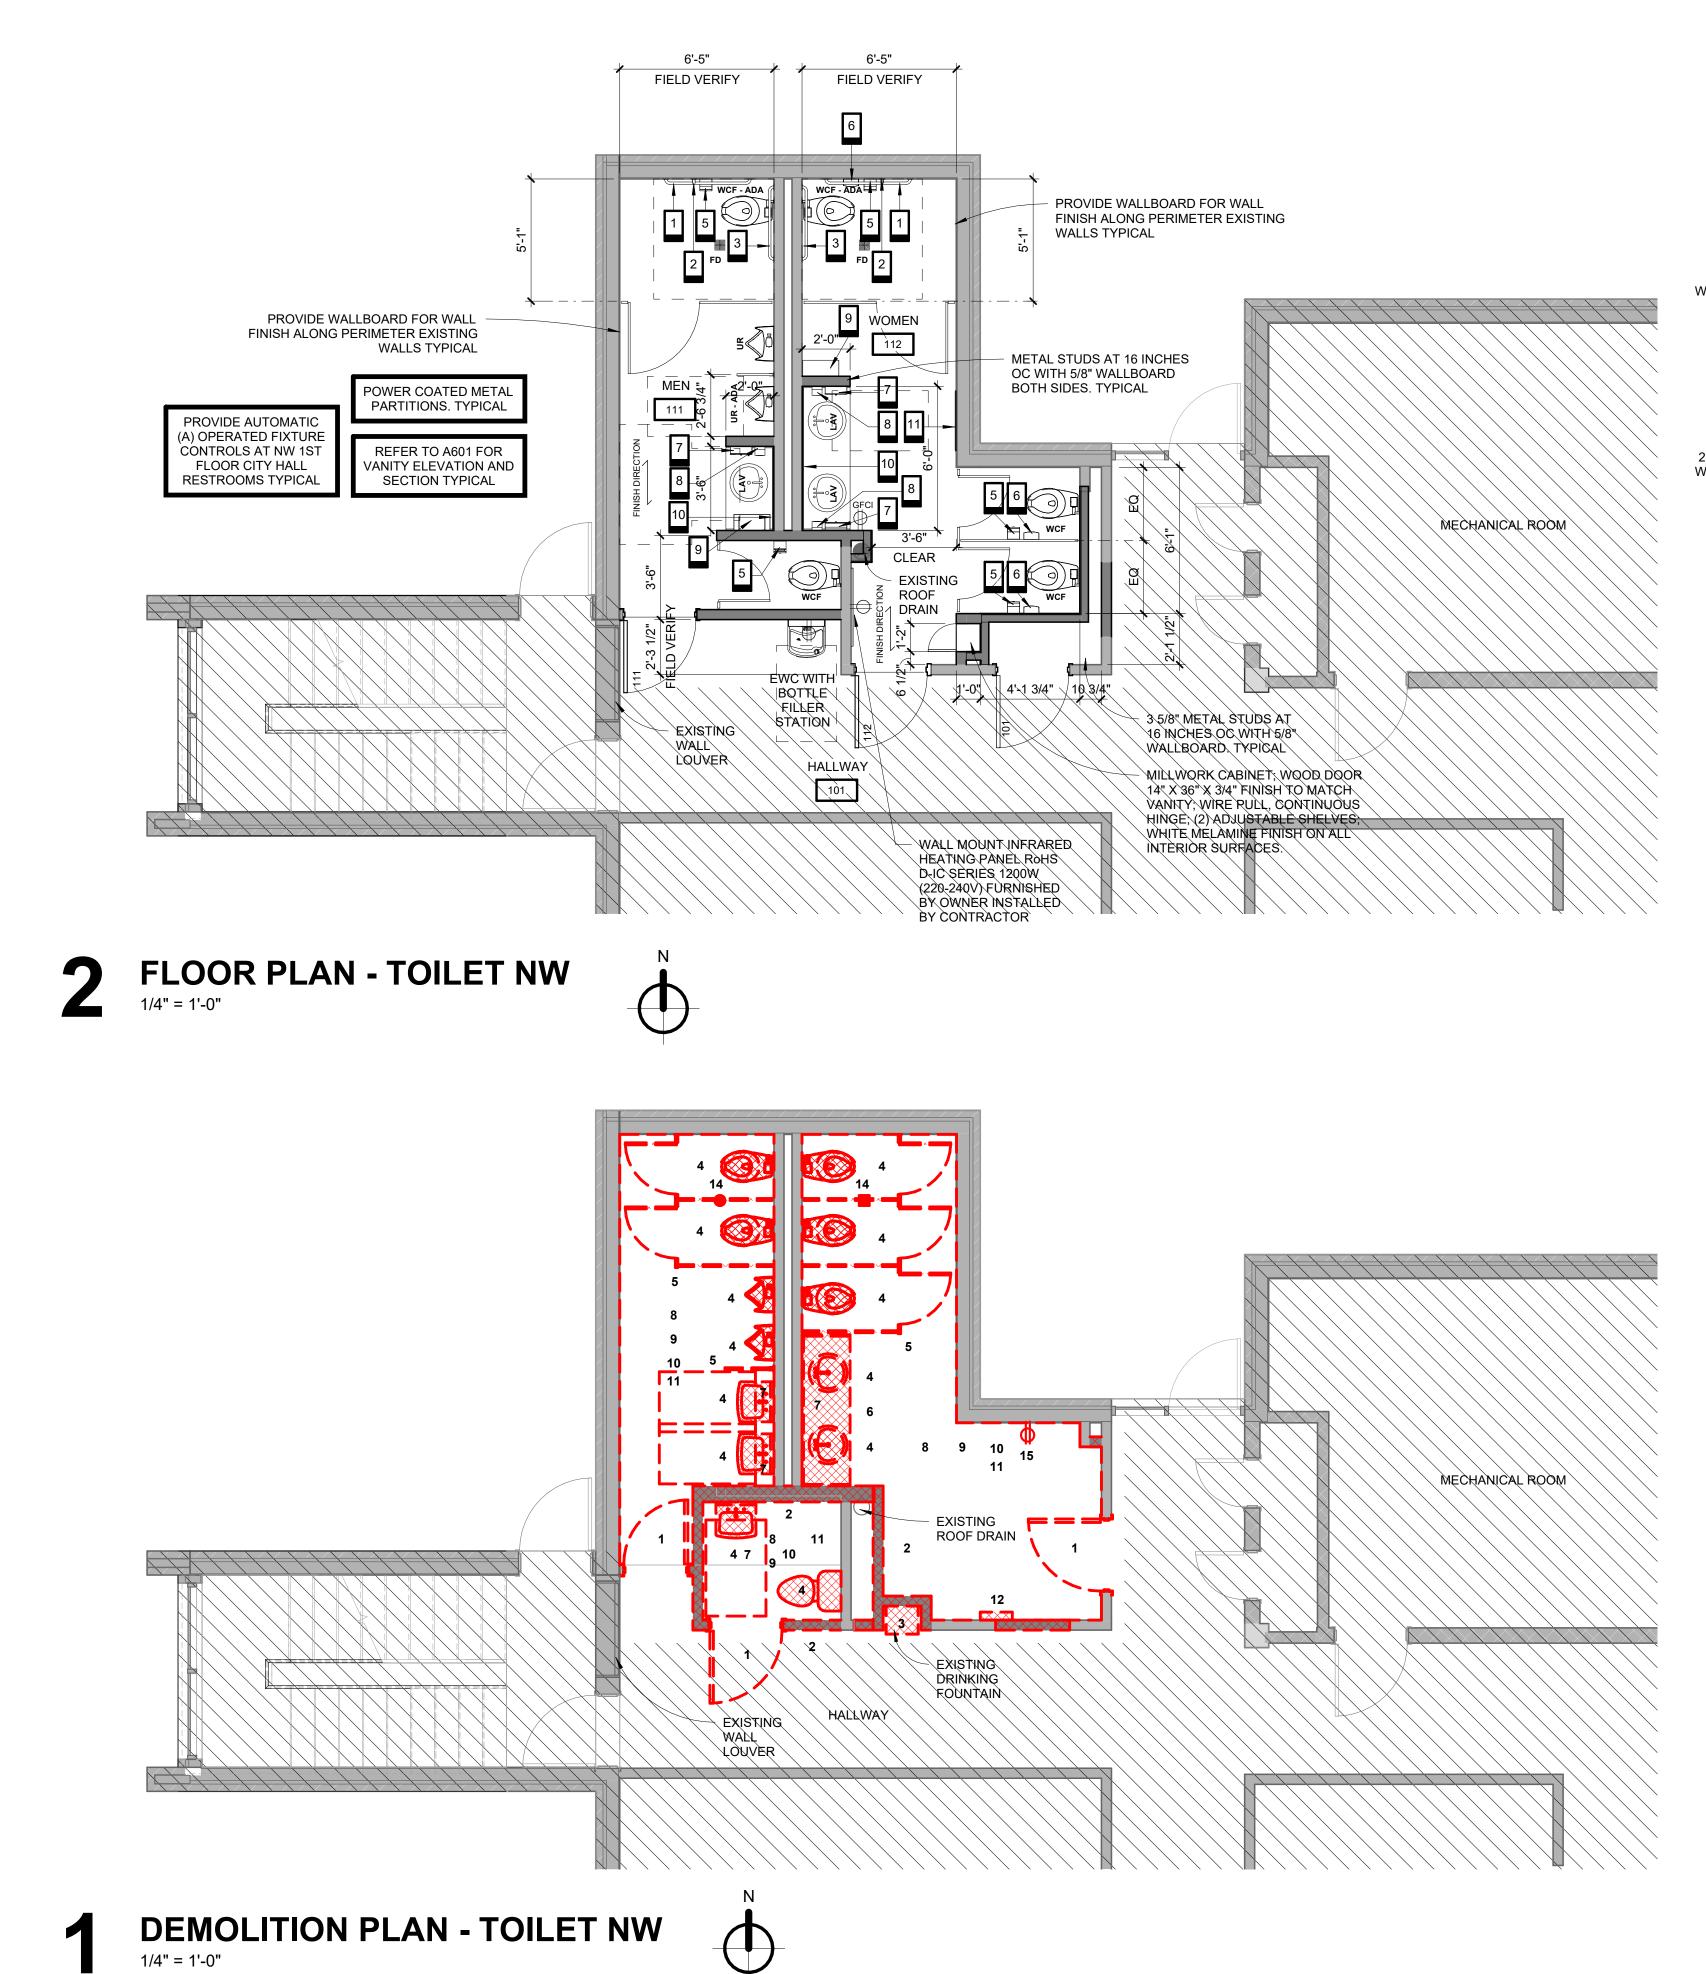

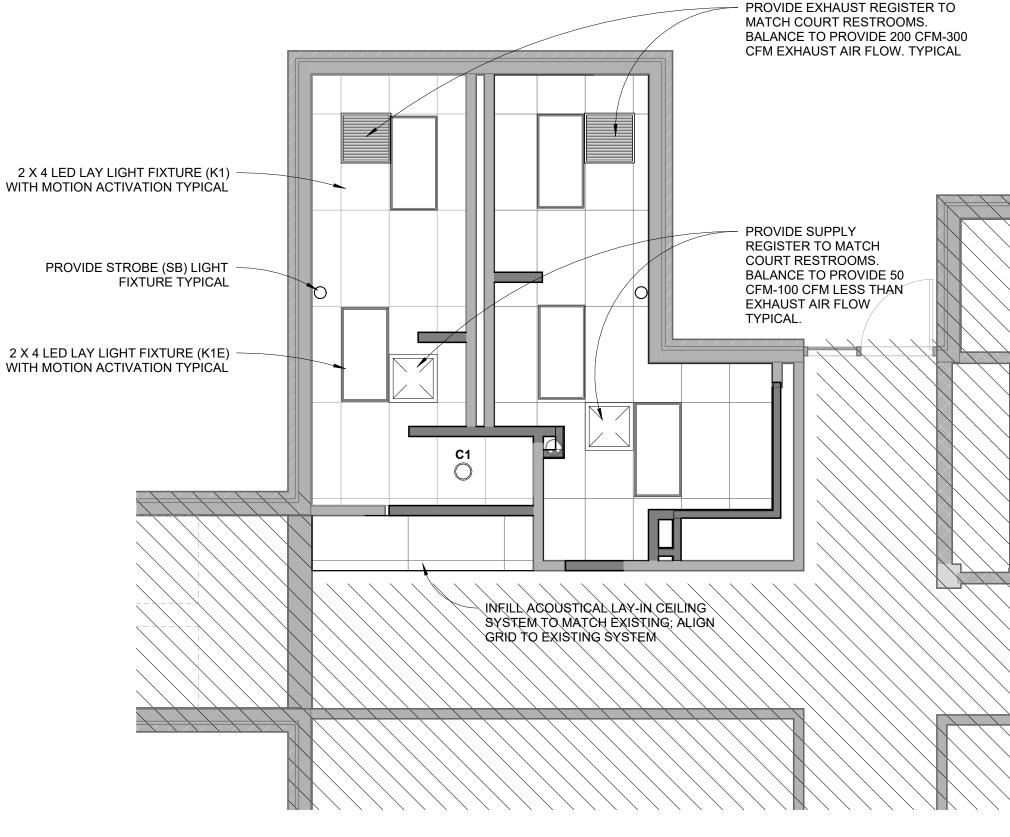



REFLECTED CEILING PLAN - TOILET NW

TOILET ROOM DEMOLITION PLAN DEMOLITION NOTES

REFER TO ELECTRICAL AND MECHANICAL DRAWINGS FOR ELECTRICAL AND MECHANICAL DEMOLITION.

- REMOVE DOOR AND FRAME
- REMOVE WALL REMOVE DRINKING FOUNTAIN
- REMOVE PLUMBING FIXTURE, SANITARY SEWER PIPING AND VENT PIPING BACK TO SANITARY SEWER AND VENT MAINS.
- REMOVE TOILET PARTITION AND ACCESSORIES REMOVE MILLWORK
- REMOVE MIRROR
- REMOVE FLOORING FINISH
- REMOVE WALL FINISH . REMOVE CEILING TILE AND GRID
- . REMOVE CEILING DIFFUSERS AND REGISTERS. CAP DUCT IN PREPARATION FOR NEW REGISTER IN NEW LOCATION.
- REMOVE AND SALVAGE SPACE HEATER (PROVIDE TO OWNER). RETAIN CIRCUIT AND WIRE ABOVE CEILING FOR RELOCATED POWER.
- REMOVE AND SALVAGE DRINKING FOUNTAIN (PROVIDE TO OWNER) . REMOVE FLOOR DRAINS AND SANITARY SEWER PIPING BACK TO SANITARY MAIN.
- 5. REMOVE RECEPTACLE AND WIRING BACK TO CEILING SPACE. RETAIN CIRCUIT FOR JUNCTION BOX TO NEW GFI RECEPTACLE







WIDWEST CITY Where the Spirit Flies High

NUMBER ISSUE DATE

REVISION



RESTROOM RENOVATION

100 NORTH MIDWEST BLVD MIDWEST CITY, OKLAHOMA

73110 ISSUE

01

ISSUE DATE 12.29.2023


PROJECT NO. 23016

DRAWN BY BT

CHECKED BY BT

SHEET TITLE CH TOILET NW FIRST FLOOR



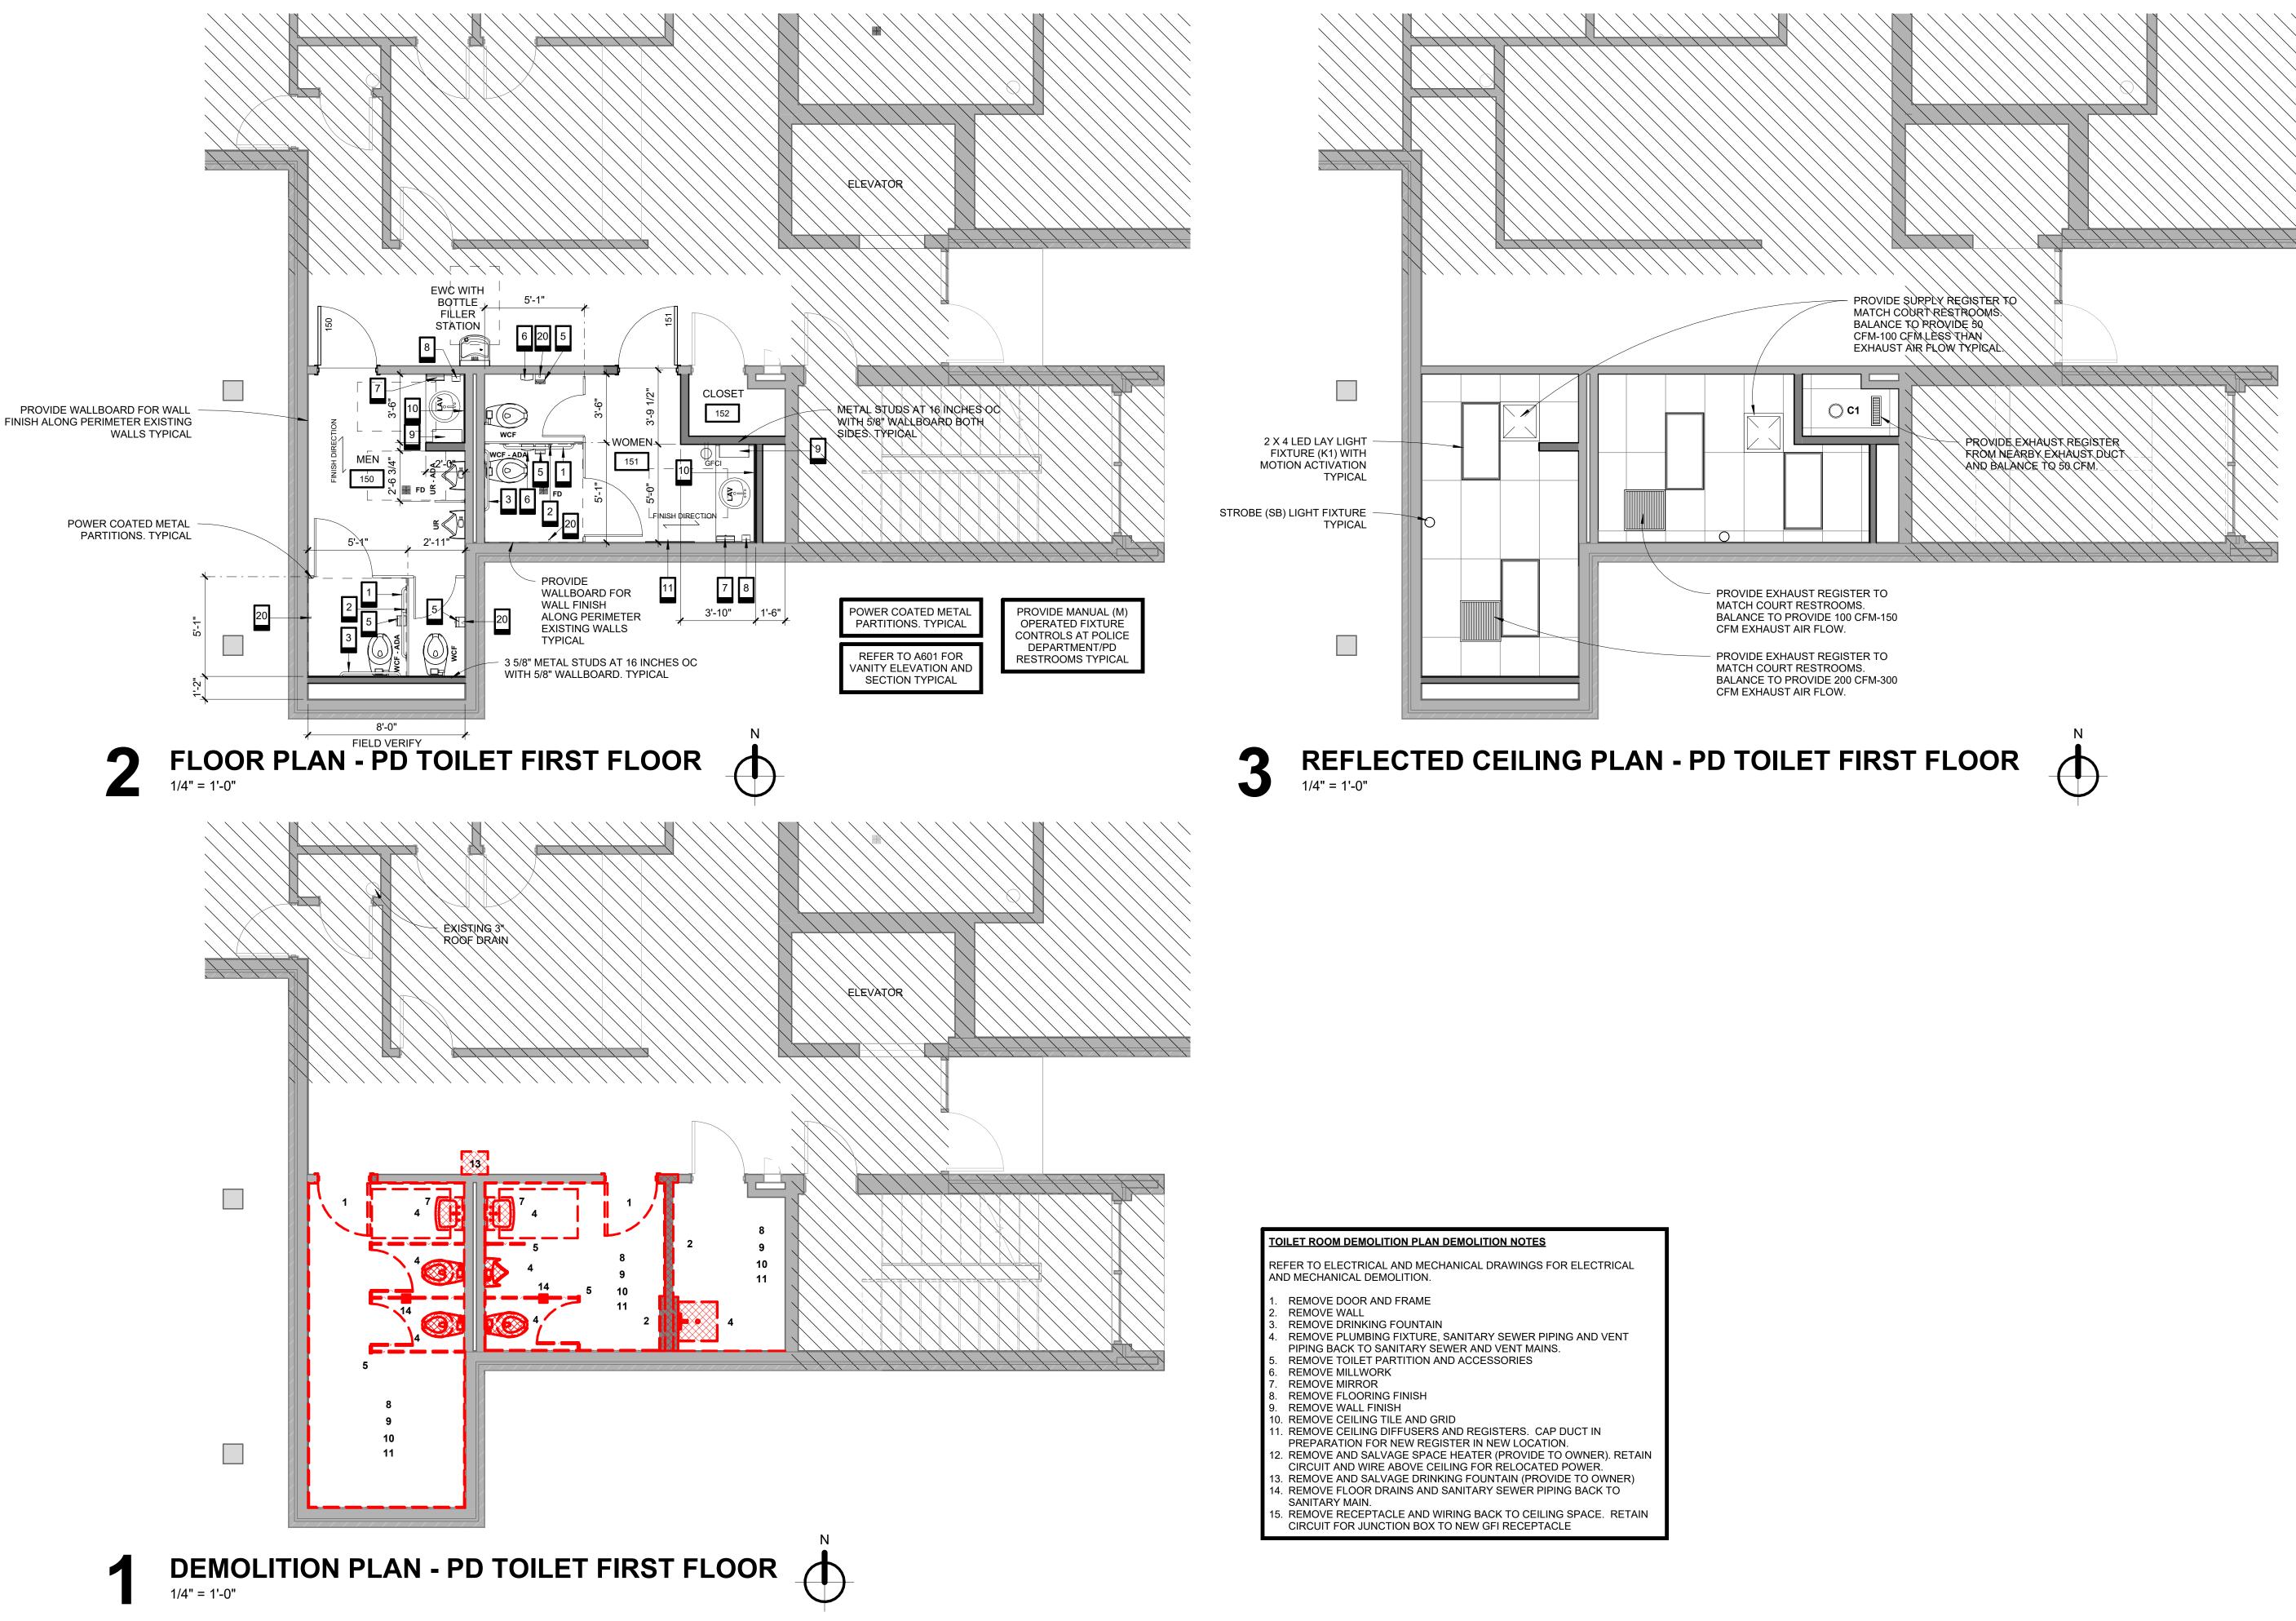

1631 S DELAWARE AVENUE TULSA, OKLAHOMA 74104 918.605.5303 WWW.505ARCHITECTS.COM

NUMBER ISSUE DATE

REVISION

MIDWEST CITY RESTROOM RENOVATION




POLICE DEPARTMENT









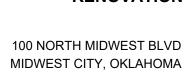

73110

ISSUE 01

ISSUE DATE 12.29.2023

> PROJECT NO. 23016

> > DRAWN BY BT

CHECKED BY BT

SHEET TITLE


FLOOR

PD TOILET FIRST

12.29.2023

A152



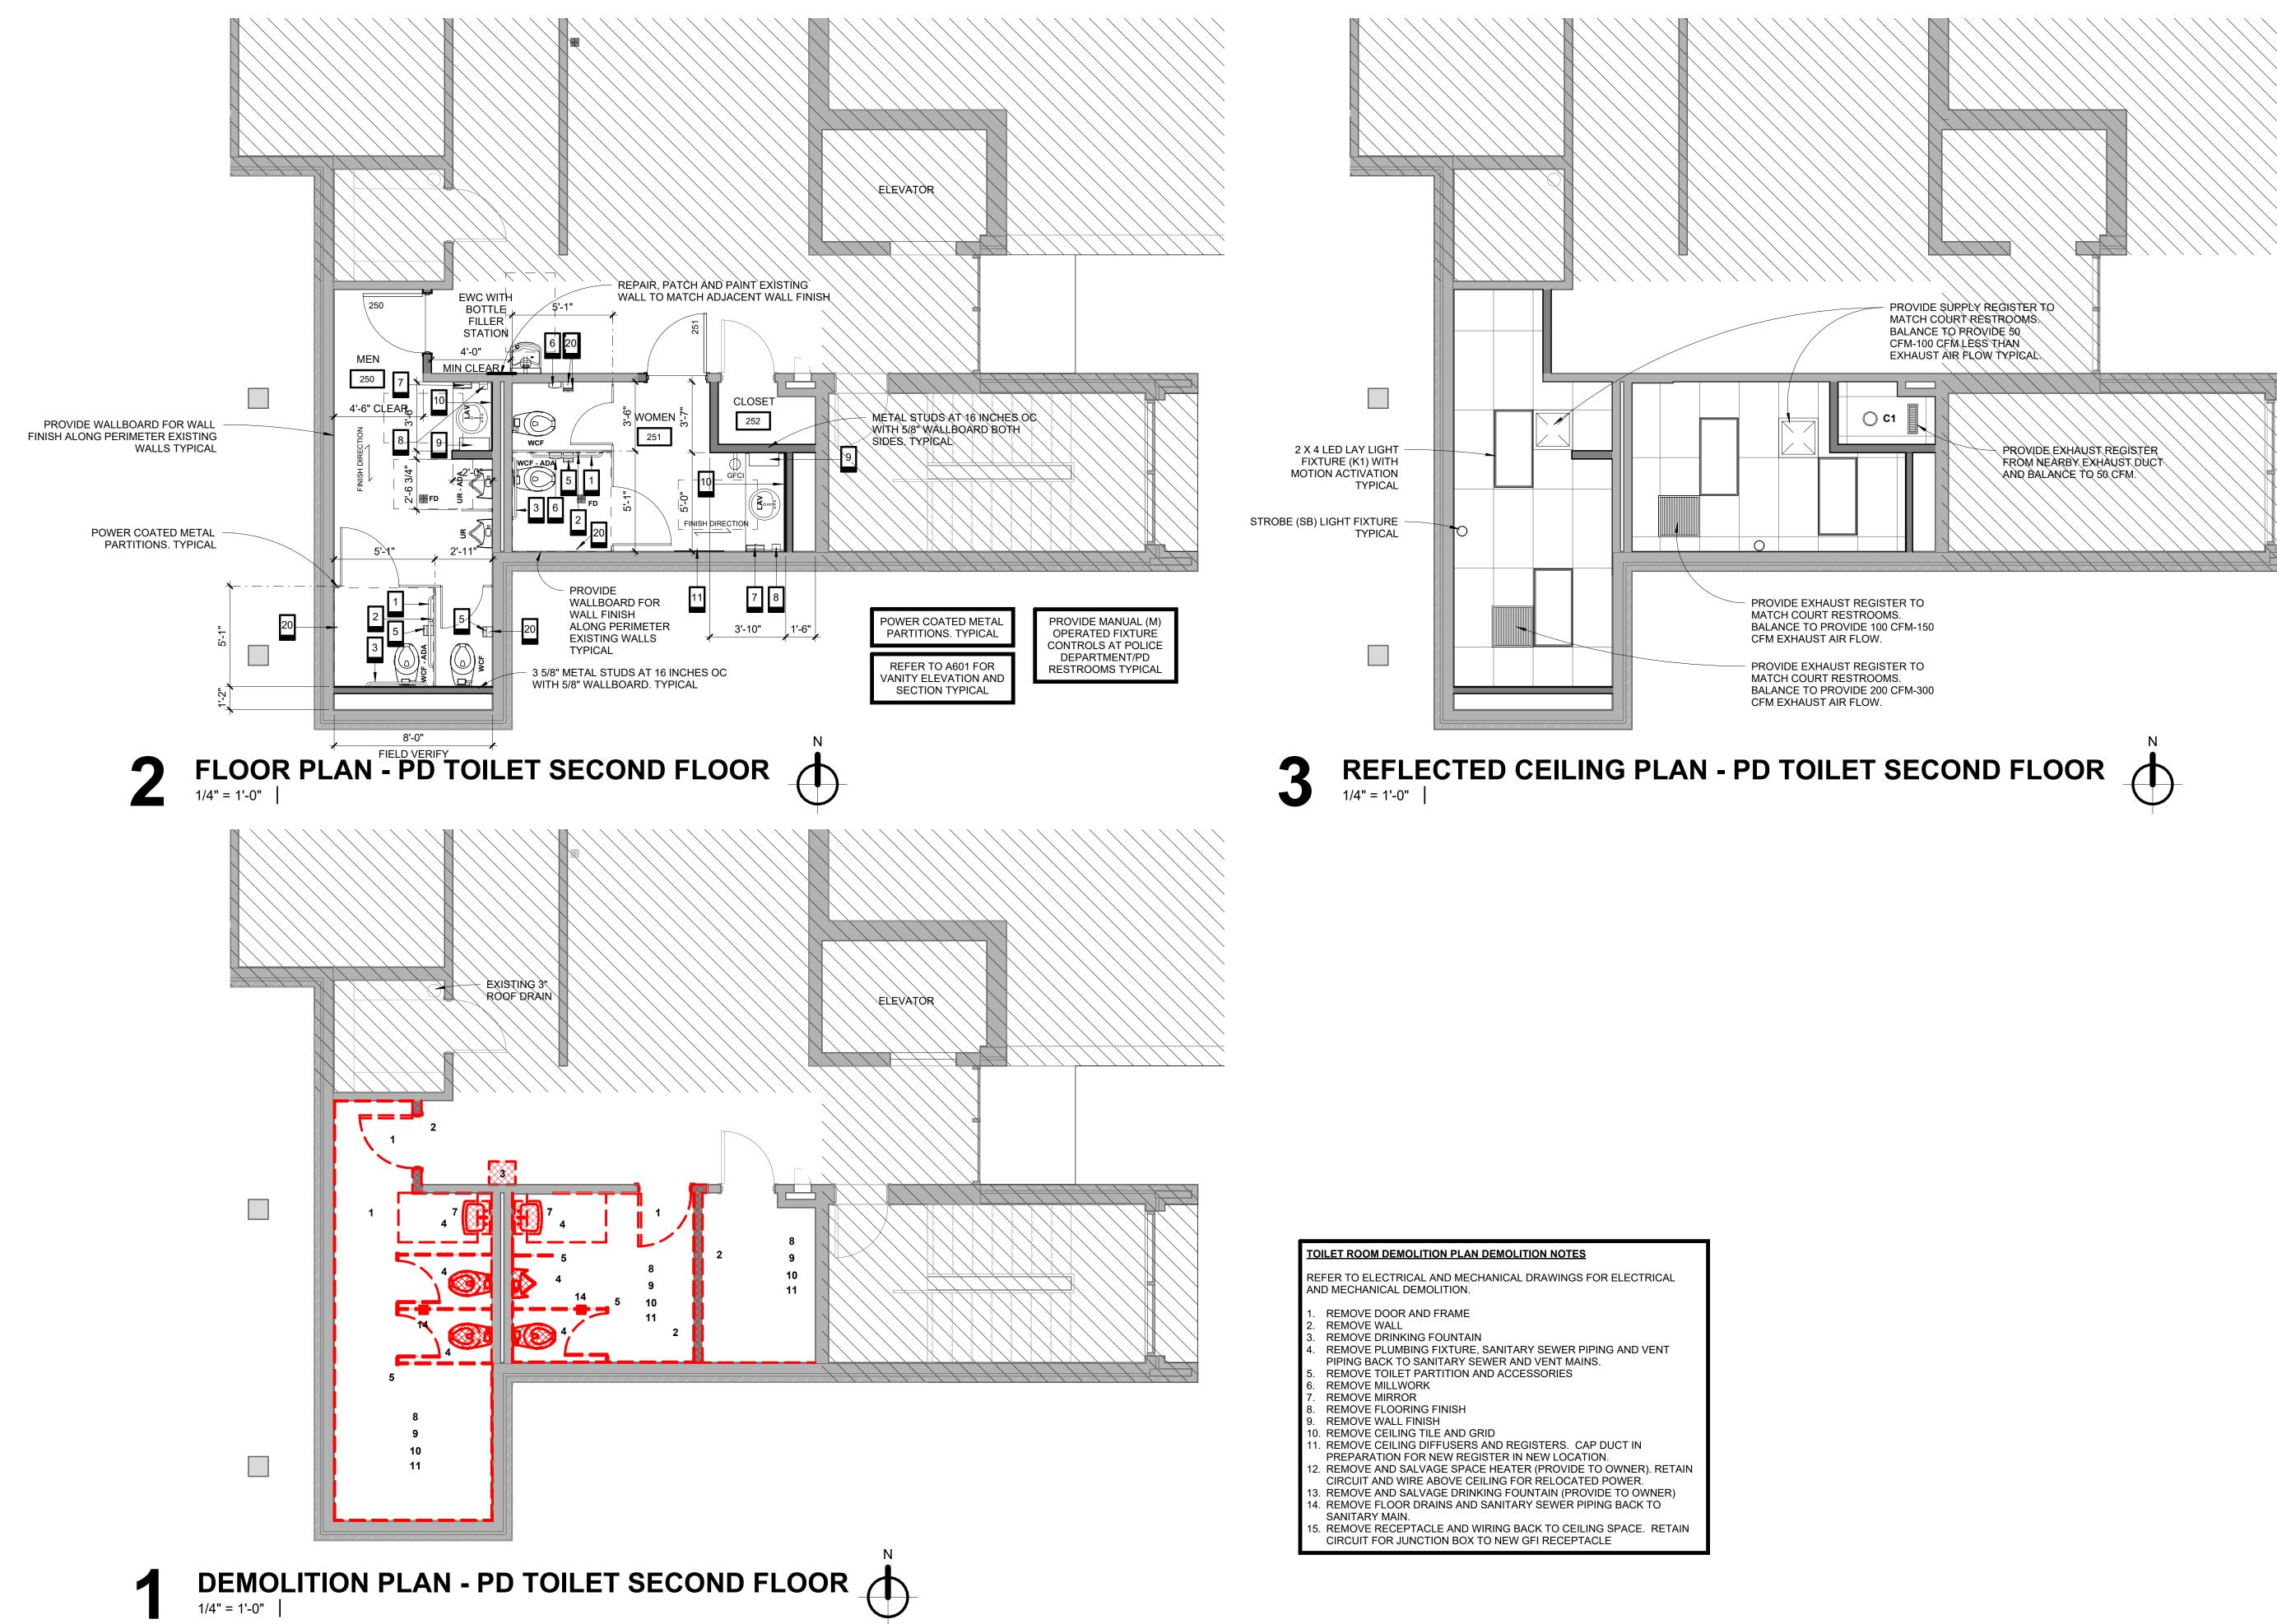



NUMBER ISSUE DATE

REVISION



RESTROOM RENOVATION

100 NORTH MIDWEST BLVD MIDWEST CITY, OKLAHOMA

73110

ISSUE 01

ISSUE DATE 12.29.2023

> PROJECT NO. 23016


















SHEET TITLE PD TOILET SECOND FLOOR



A153

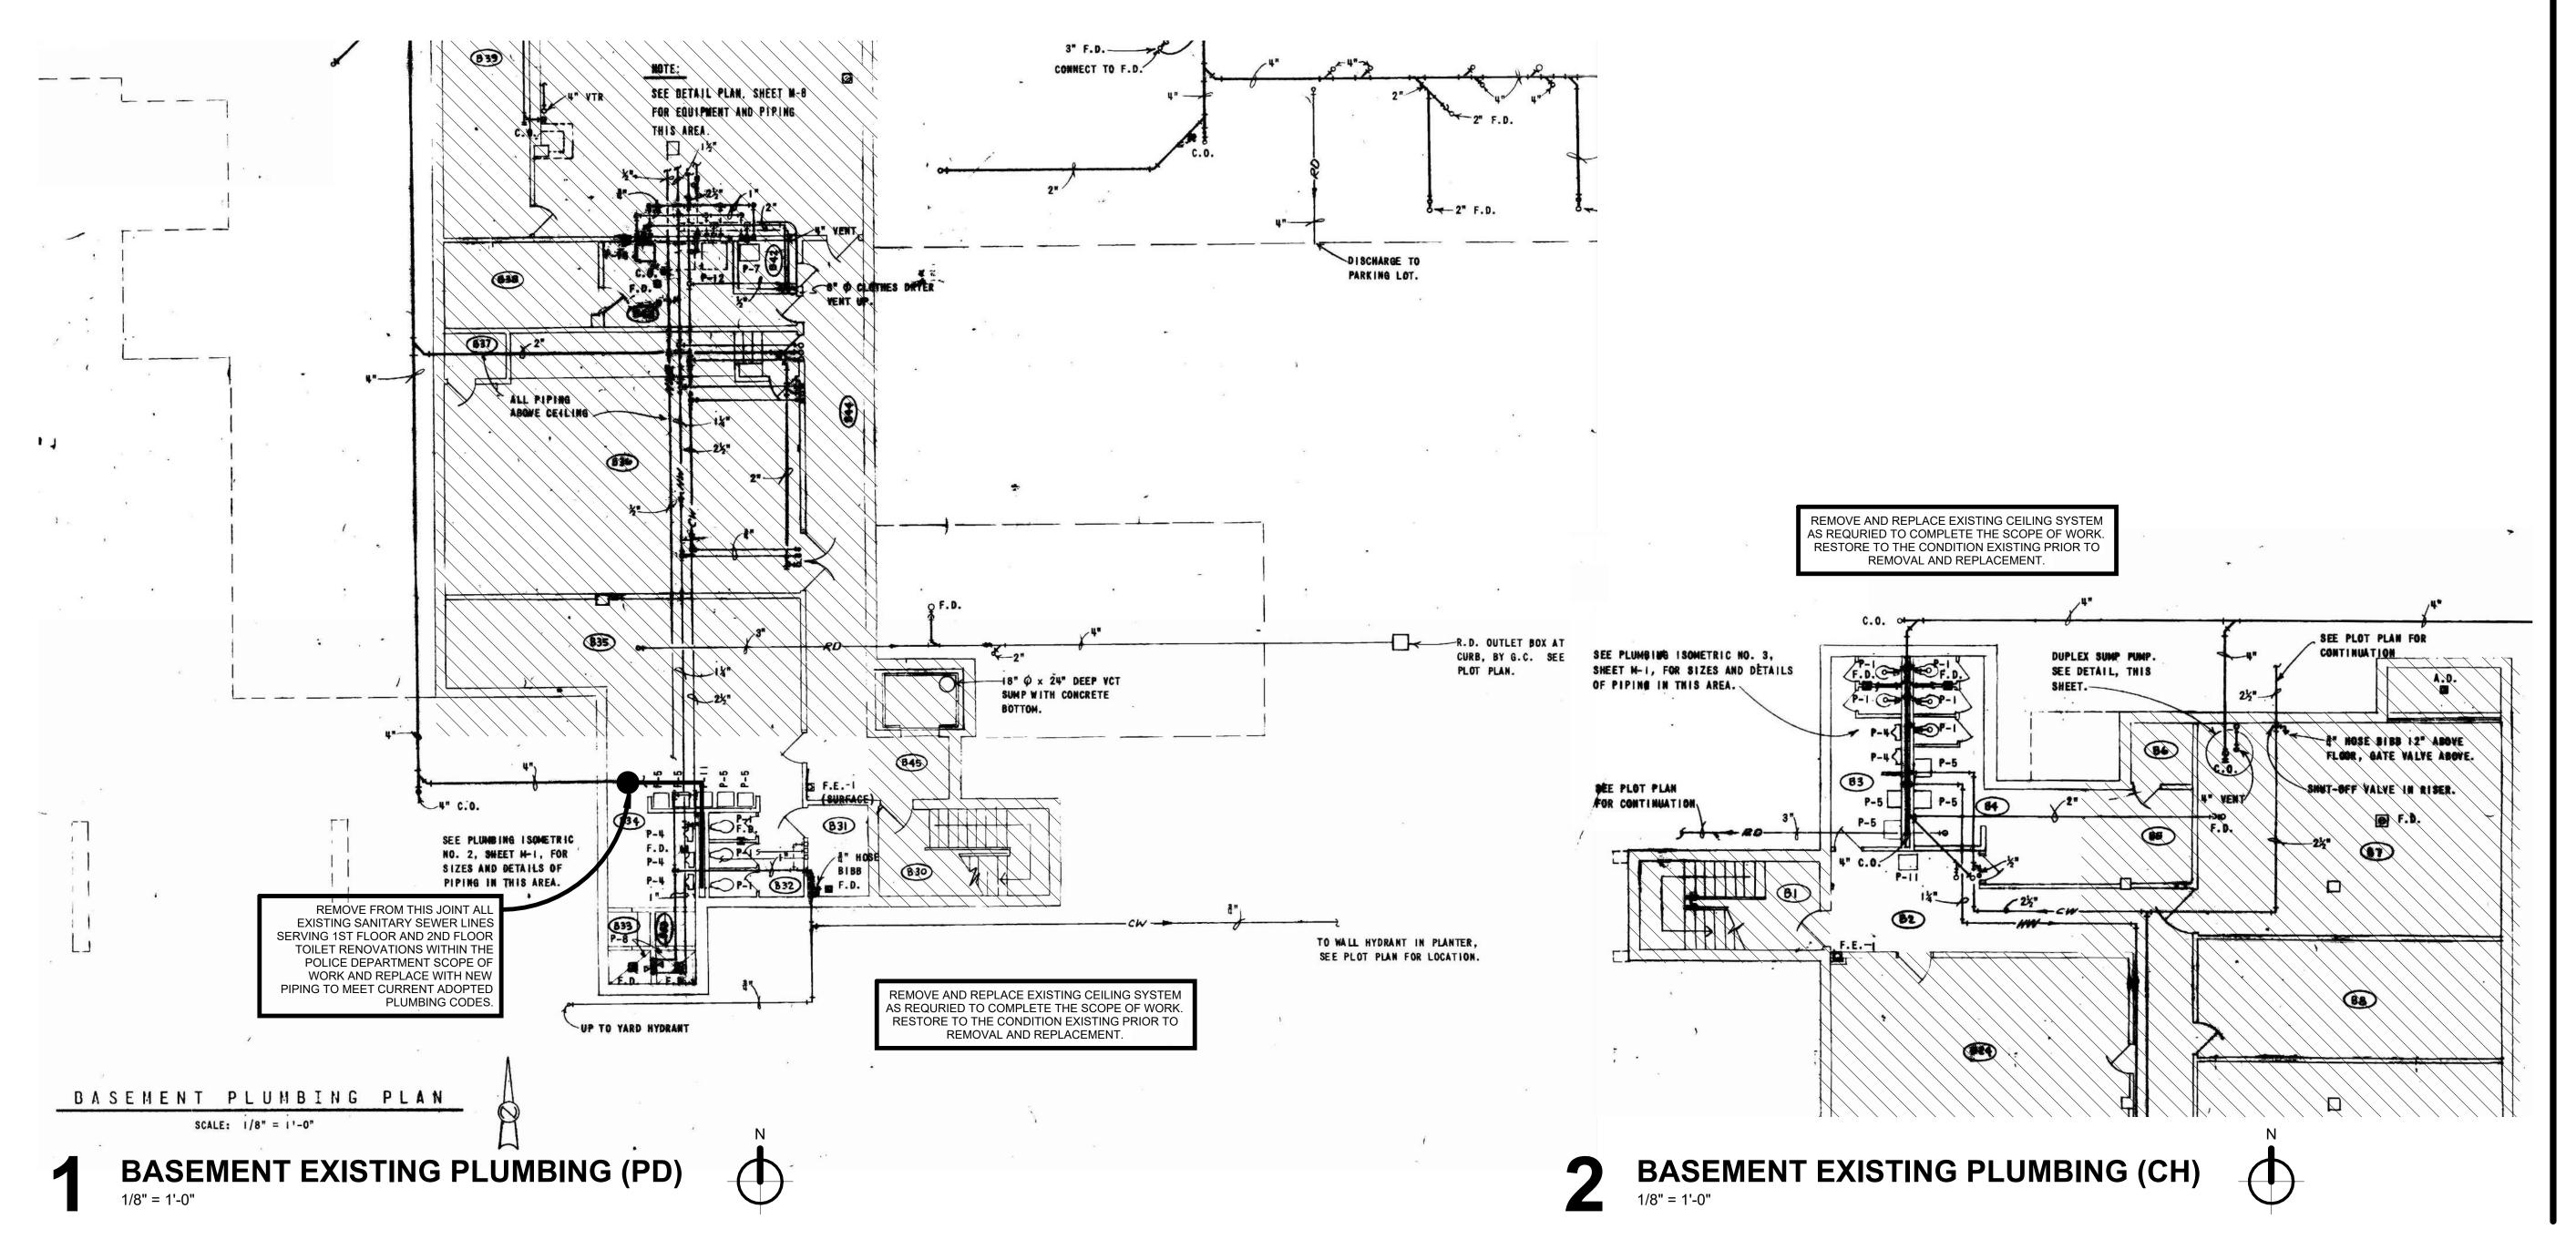



A154

© 2023 505 ARCHITECTS LLC

SHEET TITLE EXISTING BASEMENT LEVEL PLUMBING

DRAWN BY

CHECKED BY BT

PROJECT NO. **23016**

ISSUE DATE 12.29.2023

ISSUE **01**

73110

100 NORTH MIDWEST BLVD MIDWEST CITY, OKLAHOMA

POLICE DEPARTMENT RESTROOM RENOVATION

MIDWEST CITY






1631 S DELAWARE AVENUE TULSA, OKLAHOMA 74104

WWW.505ARCHITECTS.COM

918.605.5303

REVISION

NUMBER ISSUE DATE

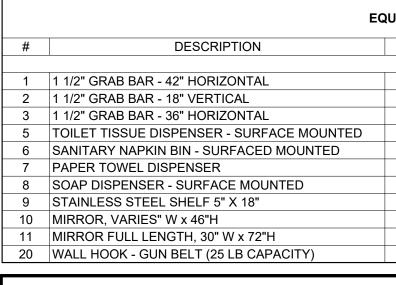

0	SANITART NAFRIN BIN - SORI AGED MOUNTED
7	PAPER TOWEL DISPENSER
8	SOAP DISPENSER - SURFACE MOUNTED
9	STAINLESS STEEL SHELF 5" X 18"
10	MIRROR, VARIES" W x 46"H
11	MIRROR FULL LENGTH, 30" W x 72"H
20	WALL HOOK - GUN BELT (25 LB CAPACITY)


8	SOAP DISPENSER - SURFACE MOUNTED	
9	STAINLESS STEEL SHELF 5" X 18"	
10	MIRROR, VARIES" W x 46"H	
11	MIRROR FULL LENGTH, 30" W x 72"H	
20	WALL HOOK - GUN BELT (25 LB CAPACITY)	
EQU	IPMENT SCHEDULE NOTES	

 \mathbf{X}

TOILET RENOVATIONS GENERAL SCOPE OF WORK

- PROVIDE ADA COMPLIANT BATHROOM ROOM SIGNAGE AT EACH TOILET ROOM DOOR
- PROVIDE SEALANT AT ALL COUNTERTOPS / BACKSPLASHES AND PLUMBING FIXTURES TYPICAL



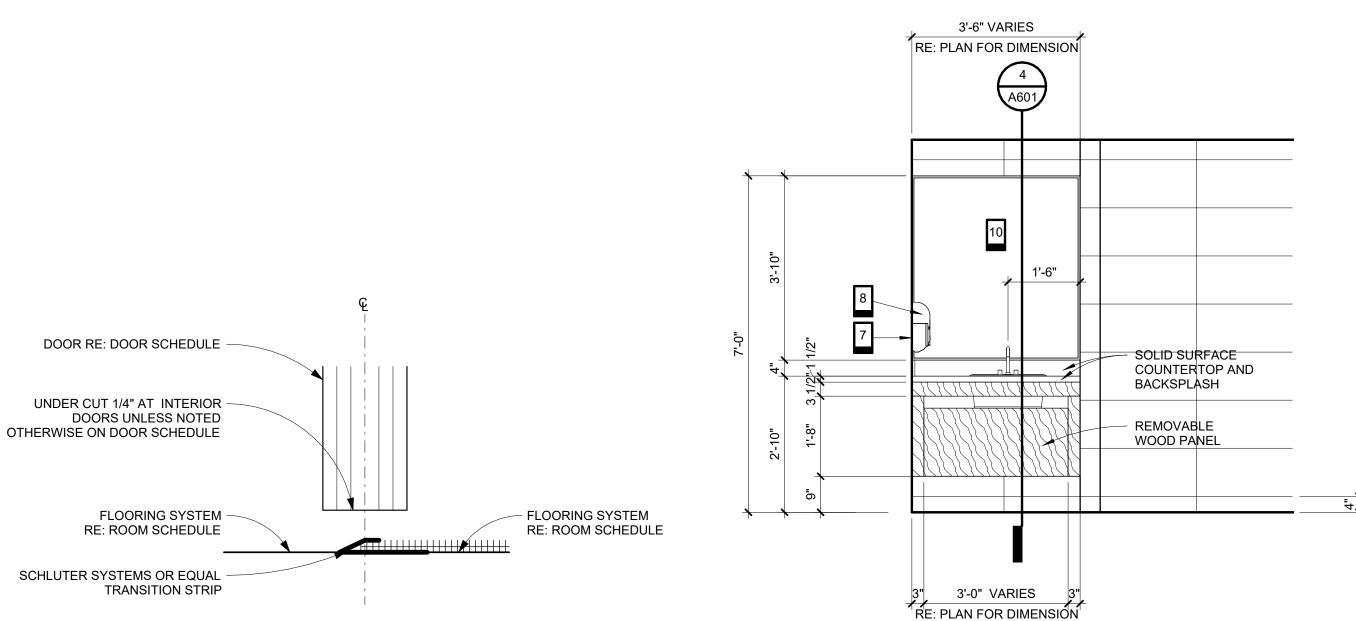






EQUIPMENT SCHEDULE FURNISHED BY INSTALLED BY FINAL HOOK-UP BY NOTES CONTRACTOR CONTRACTOR CONTRACTOR CONTRACTOR CONTRACTOR CONTRACTOR CONTRACTOR CONTRACTOR CONTRACTOR OWNER CONTRACTOR CONTRACTOR CONTRACTOR CONTRACTOR CONTRACTOR CONTRACTOR CONTRACTOR OWNER OWNER CONTRACTOR CONTRACTOR

1. PROVIDE BLOCKING IN WALL AS REQUIRED TO SUPPORT 25 LB CAPACITY

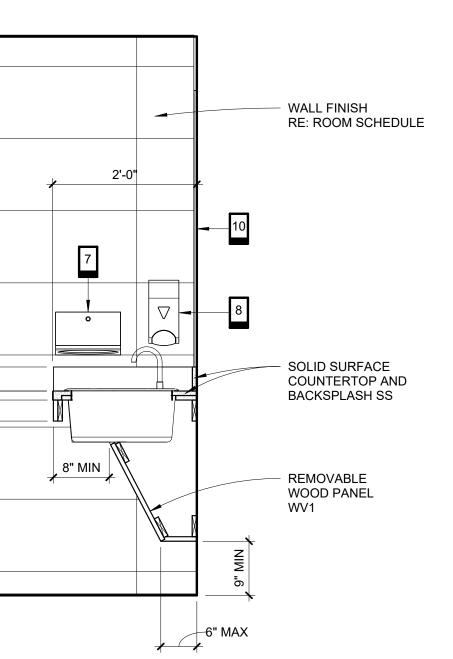

					WA	LLS
MARK	ROOM NAME	FLOOR	BASE	NORTH	EAST	
101	HALLWAY	MATCH EXIST	MATCH EXIST	PT (MATCH EXIST)	EXIST	
111	MEN	PORC	СТ	СТ	СТ	
112	WOMEN	PORC	СТ	СТ	СТ	
150	MEN	PORC	СТ	СТ	СТ	
151	WOMEN	PORC	СТ	СТ	СТ	
152	CLOSET	CONC	RUB	EXIST	EXIST	
250	MEN	PORC	СТ	СТ	СТ	
251	WOMEN	PORC	СТ	СТ	СТ	
252	CLOSET	CONC	RUB	PT (E)	PT (E)	
					•	

ROOM SCHEDULE NOTES:

CLEAN EXISTING CEILING GRID AND TOUCHUP PAINT MINOR RUST BLEMISHES

FINISH LEGE	ND:				
PAINT/COLOF	र	FLOORING		CEILINGS	
PT1 MANUF	FIELD COLOR SHERWIN WILLIAMS	BRK	EXISTING SEALED BRICK PAVER	ACT STYLE	2 X 4 X 5/8 ACOUSTICAL TILE USG RADAR ACOUSICAL PANELS
COLOR	SW 0000 TBD	PORC MANUF	PORCELAIN FLOOR TILE CAMBRIDGE OAK NATURAL AL6U	COLOR	CLIMAPLUS PERFORMANCE FLAT WHITE 050
PT2 MANUF COLOR	ACCENT PAINT SHERWIN WILLIAMS SW 0000 TBD	COLOR	NATURAL MATCH EXISTING COURT MEN TOILET	OCLON	MATCH EXISTING COURT MEN TOILET
PT3	STOREFRONT COLOR	GROUT SIZE	LATI CHESTNUT BROWN 6" X 36"	EXST	MATCH EXISTING SYSTEM
P13	MATCH EXISTING COLOR AND FINISH		0 X 30		
PT4 MANUF COLOR	DOOR FRAME COLOR SHERWIN WILLIAMS TO MATCH EXISTING	WALLS CT MANUF COLOR	GLAZED PORCELAIN TILE MARAZZI "MELODIC" CV08 MATCH EXISTING COURT MEN TOILET	WOOD VENEE WV1	R MATCH EXISTING WOOD VENEER SPECIES, STAIN, AND FINISH OF COURT MEN TOILET
		GROUT SIZE	#88 SILVER SHADOW 12" X 24" x 5/16" STACKED PATTERN 12"H X 24"W		
		TRIM	SCHLUTER - RONDEC SATIN ANODIZED ALUMINIUM	COUNTERTOP	S
				SS MANUF COLOR	SOLID SURFACE COUNTERTOP CORIAN COCOA PRIMA
					MATCH EXISTING COURT MEN TOILET COUNTERTOP

ROOM SCHEDULE

	DOOR SCHEDULE													
DOOR				DO	OR			FR	AME	HDW SET		DETAIL		
NO.	ROOM NAME	TYPE	QTY	WIDTH	HEIGHT	FINISH	GLAZING	TYPE	FINISH	NO.	HEAD	JAMB	THRESHOLD	NOTES
101	HALLWAY	F	SINGLE	3'-0"	7'-0"	WOOD		А	PT4	06			1/A601	1
111	MEN	F	SINGLE	3'-0"	7'-0"	WOOD		А	PT4	05			1/A601	1
112	WOMEN	F	SINGLE	3'-0"	7'-0"	WOOD		А	PT4	05			1/A601	1
150	MEN	F	SINGLE	3'-0"	7'-0"	WOOD		А	PT4	05			1/A601	1
151	WOMEN	F	SINGLE	3'-0"	7'-0"	WOOD		А	PT4	05			1/A601	1
250	MEN	F	SINGLE	3'-0"	7'-0"	WOOD		А	PT4	05			1/A601	1
251	WOMEN	F	SINGLE	3'-0"	7'-0"	WOOD		А	PT4	05			1/A601	1
-														

DOOR SCHEDULE NOTES

. PROVIDE DOOR LOUVER TO MATCH EXISTING SIZE AND FINISH.

2. EXISTING DOOR, FRAME, AND HARDWARE.

TOILET VANITY ELEVATION (TYPICAL)



DOOR PANEL AND FRAME TYPES N.T.S.

F FLUSH

WOOD

FINISH TO

EXISTING

EXISTING

LOUVER MATCH

FINISH FLOOR

MATCH

		CEILING		
SOUTH	WEST	TYPE	HEIGHT	NOTES
EXIST	EXIST	ACT (MATCH EXIST)	8'-0"	1
СТ	СТ	ACT	8'-6"	
СТ	СТ	ACT	8'-0"	
СТ	СТ	ACT	8'-0"	
СТ	СТ	ACT	8'-0"	
FRP	FRP	ACT	8'-0"	
СТ	СТ	ACT	8'-0"	
СТ	СТ	ACT	8'-0"	
PT	PT	ACT	8'-0"	

(E) EXISTING



1631 S DELAWARE AVENUE TULSA, OKLAHOMA 74104 918.605.5303

WWW.505ARCHITECTS.COM

NUMBER ISSUE DATE

REVISION



MIDWEST CITY POLICE DEPARTMENT RESTROOM RENOVATION

100 NORTH MIDWEST BLVD MIDWEST CITY, OKLAHOMA 73110

ISSUE **01**

ISSUE DATE 12.29.2023

PROJECT NO. 23016


DRAWN BY

CHECKED BY BT

SHEET TITLE MILLWORK





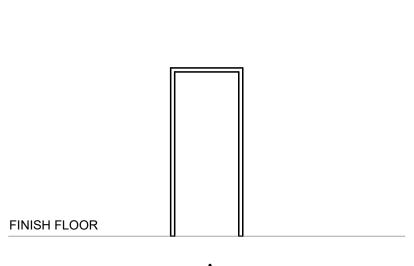



GENERAL ELECTRICAL NOTES

- ALL WORK SHALL BE PERFORMED IN STRICT COMPLIANCE WITH LATEST ADOPTED VERSION OF THE NATIONAL ELECTRICAL CODE (NEC) (INCLUDING LOCAL AMENDMENTS), AND ALL APPLICABLE FEDERAL, STATE, AND LOCAL CODES. WHERE CONFLICTS ARISE, THE MOST STRINGENT REQUIREMENT SHALL APPLY.
- IT IS THE RESPONSIBILITY OF THE CONTRACTOR TO VISIT THE PROJECT SITE PRIOR TO SUBMITTING BID IN ORDER TO VERIFY THE EXTENT OF THE CONSTRUCTION WORK AND THE ACTUAL CONDITIONS UNDER WHICH THE WORK IS TO BE PERFORMED. SUBMITTAL OF BID SHALL BE CONSIDERED PROOF THAT THE CONTRACTOR HAS VISITED THE JOB SITE AND IS FAMILIAR WITH THE SITE SPECIFIC CONSTRUCTION REQUIREMENTS.
- CONTRACTOR IS RESPONSIBLE FOR PROCURING ALL NECESSARY PERMITS AND LICENSES REQUIRED FOR WORK. PAY ALL LAWFUL FEES, INCLUDING, BUT NOT LIMITED TO UTILITY DEPOSITS, INSPECTION FEES, AND TEMPORARY AND PERMANENT CONSTRUCTION FEES.
- CONTRACTOR SHALL COORDINATE INSTALLATION OF ELECTRICAL SYSTEMS WITH OTHER TRADES. REFER TO DRAWINGS FOR EXACT LOCATIONS OF MECHANICAL AND PLUMBING EQUIPMENT. FAILURE TO COORDINATE WITH OTHER TRADES SHALL NOT RESULT IN A CHANGE ORDER.
- USE OF METALCLAD CABLE IS ACCEPTABLE FOR LIGHTING WHIPS. OTHER USES ARE SUBJECT TO APPROVAL BY ENGINEER OF RECORD PRIOR TO INSTALLATION.
- UPON COMPLETION OF ELECTRICAL INSTALLATION AND PRIOR TO ENERGIZING THE CIRCUIT: A. INSPECT WIRE AND CABLE FOR PHYSICAL DAMAGE.
 - B. PERFORM CONTINUITY TEST. C. VERIFY PROPER PHASING CONNECTION TO ALL THREE PHASE MOTOR LOADS.
- ALL EQUIPMENT SHALL BE INSTALLED IN ACCORDANCE WITH THE MANUFACTURER'S RECOMMENDATIONS. ACCEPTABLE MANUFACTURERS SHALL BE AS INDICATED FOR EQUIPMENT SCHEDULED UNLESS OTHERWISE NOTED. CONTRACTOR SHALL PROVIDE ALL NECESSARY WIRING AND EQUIPMENT AND MAKE ALL FINAL CONNECTIONS FOR A COMPLETE AND OPERATIONAL SYSTEM.
- RETAIN ALL EXISTING CIRCUITING, SWITCHING ZONES AND LOCATIONS.
- PROVIDE GFCI RECEPTACLE IN NEW JUNCTION BOX AT LOCATIONS INDICATED ON DRAWINGS
-). PROVIDE POWER FOR AUTOMATIC FLUSH VALUES AT PLUMBING FIXTURES AS REQUIRED.

GENERAL LIGHTING NOTES

- THE LOCATION OF DUCTS, PIPE AND EQUIPMENT AS SHOWN ON THE DRAWINGS IS DIAGRAMMATIC AND SCHEMATIC AND IT IS THE RESPONSIBILITY OF THE CONTRACTOR TO COORDINATE WITH ALL OTHER TRADES BEFORE INSTALLATION. LIGHT FIXTURE LOCATIONS SUPERSEDE HVAC DUCTWORK, GRILLES AND DIFFUSERS. OFFSET TO AVOID STRUCTURE AND/OR ANY OTHER PIPING.
- COORDINATE EXACT FIXTURE LOCATIONS WITH STRUCTURE, DIFFUSERS, ETC.
- WHERE FIELD CONDITIONS WILL INTERFERE WITH THE INTENDED LIGHTING LAYOUT, CONTRACTOR IS RESPONSIBLE FOR NOTIFYING THE ARCHITECT.
- PROVIDE ALL ACCESSORIES, CABLES AND CONNECTIONS REQUIRED FOR FUNCTIONAL ELECTRICAL AND LIGHTING INSTALLATION AND SUPPORT.
- PROVIDE TWO COPIES OF OPERATION AND MAINTENANCE MANUALS FOR ALL LIGHT FIXTURES.

<u>IGHT FIXTURE SCHEDULE</u>

PROVIDE LED LIGHT FIXTURES AND MOTION SENSOR LIGHTING CONTROLS TO MATCH COURT MEN TOILET ROOM AS FOLLOWS:

- 2X4 LAY-IN FLAT PANEL LED METALUX 24FP4740C
- 6" RECESSED LED DOWNLIGHT WITH LENS PORTFOLIO LD6C 15 90 40 D010 M 0 H
- STROBE LIGHT
- TO MATCH EXISTING
- IGHTING CONTROLS MOTION SENSING DUAL TECH ACTIVATED LIGHT SWITCH (PROVIDE ONE PER RESTROOM TYPICAL)

TOILET RENOVATION PLUMBIN

- REMOVE EXISTING PLUMBI SURVEY BUILDING TO DETI SERVING THE NW 1ST FLOO
- PROVIDE NEW COLD WATE
- LOCATION OR PROVIDE AC MODIFY EXISTING SEWER,
- PROVIDE ANGLE STOPS AN PROVIDE NEW TYPE 'A' WA
- SURVEY EXISTING PLUMBIN WITH CURRENT PLUMBING
- PROVIDE NEW SANITARY S COORDINATED WITH THE A
- PROVIDE NEW PLUMBING F CONTRACTOR TO VERIFY E
- 0. PROVIDE DRINKING FOUNT 11. PROVIDE ASSE 1070 MIXING
- 12. PROVIDE TRUBRO LAV GUA 13. FIELD VERIFY IF TRAP PRIM
- TRAP GUARDS FOR FLOOR 14. PROVIDE NEW WALL CARRI
- 15. CAULK NEW FIXTURES TO 16. WHERE POSSIBLE, CONNER
- AVOID ANY NEW ROOF WOI
- 17. REROUTE EXISTING IN-WAI 18. PROVIDE TWO COPIES OF

TOILET RENOVATIONS PLUMB

- PLUMBING INSTALLATION VALVES SHALL BE LINE SIZ
- PIPING IN FINISHED AREAS AND TIGHT TO WALLS. NOT
- INSULATE PIPING ROUTED WATER LINES SHALL BE INS
- RECIRCULATING LINES SHALL BE INSULATED WITH MINIMUM OF 1" BLACK CLOSED CELL INSULATION.
- COORDINATE ALL WORK WITH OTHER TRADES AND CONTRACTORS. CLEAN FAUCET AERATORS AND PIPE STRAINERS PRIOR TO TURNING BUILDING OVER TO OWNER
- AND ARE NOT WITHIN 2' OF ANY OTHER EQUIPMENT.
- CODES.
- VENTED. 12. CUTOFF VALVES AND STOPS SHALL BE PROVIDED AT FIXTURE CONNECTIONS.

- 15. SLOPE 3" AND 4" SANITARY SEWER AT 1/8" PER FOOT.
- 17. DOMESTIC HOT WATER CIRCULATION LOOP SHALL DROP INTO WALL/PLUMBING CHASE TO WITHIN 6 INCHES OF THE TAKE-OFF FOR THE FIXTURE SERVED.

REMOVE ALL EXISTING SANITARY SEWER LINES SERVING 1ST FLOOR AND 2ND FLOOR TOILET RENOVATIONS WITHIN THE POLICE DEPARTMENT SCOPE OF WORK AND REPLACE WITH NEW PIPING TO MEET CURRENT ADOPTED PLUMBING CODES. REFER TO SHEET A154.

TOILET RENOVATION PLUMBING SCOPE OF WORK: 1. REMOVE EXISTING PLUMBING FIXTURES AND FLOOR DRAINS AS SHOWN. 2. SURVEY BUILDING TO DETERMINE LOCATION AND CONDITION OF NEAREST ACTIVE DOMESTIC WATER LINES AND SANITARY SEWER LINES SERVING THE WI ST FLOOR AND POLICE DEPARTMENT TOILET ROOMS. 3. PROVIDE NEW COLD WATER AND HOT WATER ISOLATION VALVES TO ISOLATE EACH BATHROOM GROUP (TYP 3). INSTALL VALVES IN ACCESSIBLE LOCATION OR PROVIDE ACCESS PANEL TO ACCESS VALVES. COORDINATE ACCESS PANEL LOCATION, SIZE, AND COLOR WITH ARCHITECT. 4. MODIFY EXISTING SEWER, VENT, HOT WATER, AND COLD WATER LINES TO ACCOMMODATE NEW FIXTURES. 5. PROVIDE NEW TOYE A' WATER HAMMER ARRESTORS AT THE END OF EACH COLD WATER LINE SERVING TOILETS. 7. SURVEY SEXISTING PLUMBING SYSTEMS TO DETERMINE EXISTING PLUMBING MATERIAL TYPES, ALL NEW PIPING MATERIALS SHALL COMPLY WITH CURRENT PLUMBING CODE. 8. PROVIDE NEW SANITARY SEWER WALL CLEANOUTS. CLEANOUTS SHALL BE LOCATED PER APPLICABLE PLUMBING GODES AND SHALL BE COORDINATED WITH THE ARCHITECT. 9. PROVIDE NEW SANITARY SEWER WALL CLEANOUTS. CLEANOUTS SHALL BE LOCATED PER APPLICABLE PLUMBING GODES AND SHALL BE COORDINATED WITH THE ARCHITECT. 9. PROVIDE NEW SANITARY SEWER VALL CLEANOUTS. CLEANOUTS SHALL BE LOCATED PER APPLICABLE. PLUMBING GODES AND SHALL BE COORDINATION WITH HOTTLE FILLER. 11. PROVIDE ASSE 1070 MINING VALVES AT ALL LAVATORY SENTAND OPERABLE. THON OCUNCIL CHAMBERS RESTROOM GROUP. 10. PROVIDE NEW PLUMBING STATURES AND AUTOMATIC FLUSH		
 SURVEY BUILDING TO DETERMINE LOCATION AND CONDITION OF NEAREST ACTIVE DOMESTIC WATER LINES AND SANITARY SEWER LINES SERVING THE NW 1ST FLOOR AND POLICE DEPARTMENT TOLUET ROOMS. PROVIDE NEW COLD WATER AND HOT WATER ISOLATION VALVES TO ISOLATE EACH BATHROOM GROUP (TYP 3), INSTALL VALVES IN ACCESSIBLE LOCATION OR POVIDE ACCESS PAREL TO ACCESS VALVES, COORDINATE ACCESS PAREL LOCATION, SIZE, AND COLOR WITH ARCHITECT. MODIFY EXISTING SEWER, VENT, HOT WATER, AND COLD WATER LINES TO ACCOMMODATE NEW FIXTURES. PROVIDE ANGLE STOPS AND ESCUSION PLATES AT LAVATORY AND DRINKING FOUNTAIN DOMESTIC WATER STUB-INS THROUGH WALL. PROVIDE NEW TYPE ''' WATER HAMMER ARRESTORS AT THE END OF EACH COLD WATER LINE SERVING TOLLETS. SURVEY EXISTING PLUMBING SYSTEMS TO DETERMINE EXISTING PLUMBING MATERIAL TYPES, ALL NEW PIPING MATERIALS SHALL COMPLY WITH CURRENT PLUMBING SYSTEMS TO DETERMINE EXISTING PLUMBING MATERIAL TYPES, ALL NEW PIPING MATERIALS SHALL COMPLY WITH CURRENT PLUMBING SYSTEMS TO DETERMINE EXISTING PLUMBING MATERIAL TYPES, ALL NEW PIPING MATERIALS SHALL COMPLY WITH CURRENT PLUMBING SYSTEMS TO DETERMINE EXISTING PLUMBING MATERIAL TYPES, ALL NEW PIPING MATERIALS SHALL COMPLY WITH CURRENT PLUMBING SYSTEMS TO DETERMINE EXISTING PLUMBING MATERIAL TYPES, ALL NEW PIPING MATERIALS SHALL COMPLY WITH CURRENT PLUMBING FIXTURES AND AUTOMATIC FLUSH CONTROLS TO MATCH FIXTURES IN COUNCIL CHAMBERS RESTROOM GROUP. COORDINATED WITH THE ARCHITECT. PROVIDE NEW PLUMBING FIXTURES AND AUTOMATIC FLUSH CONTROLS TO MATCH FIXURES IN COUNCIL CHAMBERS RESTROOM GROUP. PROVIDE NEW PLUMBING VALVES AT ALL LAVATORIES. PROVIDE ASSE 1070 MIXING VALVES AT ALL LAVATORIES. PROVIDE RUBRD LAVA QUARD II (OS SIMLAR) PROTECTION FOR PLUMBING LINES UNDRER	TO	LET RENOVATION PLUMBING SCOPE OF WORK:
 SURVEY BUILDING TO DETERMINE LOCATION AND CONDITION OF NEAREST ACTIVE DOMESTIC WATER LINES AND SANITARY SEWER LINES SERVING THE NW 1ST FLOOR AND POLICE DEPARTMENT TOLUET ROOMS. PROVIDE NEW COLD WATER AND HOT WATER ISOLATION VALVES TO ISOLATE EACH BATHROOM GROUP (TYP 3), INSTALL VALVES IN ACCESSIBLE LOCATION OR POVIDE ACCESS PAREL TO ACCESS VALVES, COORDINATE ACCESS PAREL LOCATION, SIZE, AND COLOR WITH ARCHITECT. MODIFY EXISTING SEWER, VENT, HOT WATER, AND COLD WATER LINES TO ACCOMMODATE NEW FIXTURES. PROVIDE ANGLE STOPS AND ESCUSION PLATES AT LAVATORY AND DRINKING FOUNTAIN DOMESTIC WATER STUB-INS THROUGH WALL. PROVIDE NEW TYPE ''' WATER HAMMER ARRESTORS AT THE END OF EACH COLD WATER LINE SERVING TOLLETS. SURVEY EXISTING PLUMBING SYSTEMS TO DETERMINE EXISTING PLUMBING MATERIAL TYPES, ALL NEW PIPING MATERIALS SHALL COMPLY WITH CURRENT PLUMBING SYSTEMS TO DETERMINE EXISTING PLUMBING MATERIAL TYPES, ALL NEW PIPING MATERIALS SHALL COMPLY WITH CURRENT PLUMBING SYSTEMS TO DETERMINE EXISTING PLUMBING MATERIAL TYPES, ALL NEW PIPING MATERIALS SHALL COMPLY WITH CURRENT PLUMBING SYSTEMS TO DETERMINE EXISTING PLUMBING MATERIAL TYPES, ALL NEW PIPING MATERIALS SHALL COMPLY WITH CURRENT PLUMBING SYSTEMS TO DETERMINE EXISTING PLUMBING MATERIAL TYPES, ALL NEW PIPING MATERIALS SHALL COMPLY WITH CURRENT PLUMBING FIXTURES AND AUTOMATIC FLUSH CONTROLS TO MATCH FIXTURES IN COUNCIL CHAMBERS RESTROOM GROUP. COORDINATED WITH THE ARCHITECT. PROVIDE NEW PLUMBING FIXTURES AND AUTOMATIC FLUSH CONTROLS TO MATCH FIXURES IN COUNCIL CHAMBERS RESTROOM GROUP. PROVIDE NEW PLUMBING VALVES AT ALL LAVATORIES. PROVIDE ASSE 1070 MIXING VALVES AT ALL LAVATORIES. PROVIDE RUBRD LAVA QUARD II (OS SIMLAR) PROTECTION FOR PLUMBING LINES UNDRER	4	
SERVING THE INV 1ST FLOOR AND POLICE DEPARTMENT TOILET ROOMS. PROVIDE NEW COLD WATER AND HOT WATER IND TO ACCESS VALVES. COORDINATE ACCESS PAREL LOCATION, SIZE, AND COLOR WITH ARCHITECT. 4. MODIFY EXISTING SEWER, VENT, HOT WATER, AND COLD WATER LINES TO ACCOMMODATE NEW FIXTURES. 5. PROVIDE ANGLE STOPS AND ESCUSION PLATES AT LAVATORY AND DRINKING FOUNTAIN DOMESTIC WATER STUB-INS THROUGH WALL. 5. PROVIDE NAGLE STOPS AND ESCUSION PLATES AT LAVATORY AND DRINKING FOUNTAIN DOMESTIC WATER STUB-INS THROUGH WALL. 5. PROVIDE NEW TYPE 'A WATER HAMMER ARRESTORS AT THE END OF EACH COLD WATER LINE SERVING TOILETS. 5. SURVEY EXISTING PLUMBING SYSTEMS TO DETERMINE EXISTING PLUMBING MATERIAL NEW PIPING MATERIALS SHALL COMPLY WITH CURRENT PLUMBING CODE. 5. PROVIDE NEW SANITARY SEWER WALL CLEANOUTS. CLEANOUTS SHALL BE LOCATED PER APPLICABLE PLUMBING CODES AND SHALL BE COORDINATED WITH THE ARCHITECT. 5. PROVIDE NEW SANITARY SEWER WALL CLEANOUTS. CLEANOUTS SHALL BE LOCATED PER APPLICABLE PLUMBING CODES AND SHALL BE COORDINATED WITH THE ARCHITECT. 5. PROVIDE NEW SANITARY SEWER WALL CLEANOUTS. CLEANOUTS SHALL BE LOCATED PER APPLICABLE PLUMBING CODES AND SHALL BE COORDINATED WITH THE ARCHITECT. 5. PROVIDE NEW SANITARY SEWER WALL CLEANOUTS. CLEANOUTS SHALL BE LOCATED PER APPLICABLE PLUMBING CODES AND SHALL BE COORDINATED OLIVER OUNTAIN TO MATCH COUNCIL CHAMBER SINGLE DRINKING FOUNTAIN WITH BOTTLE FILLER. 11. PROVIDE ASSE 1070 MIXING VALVES AT ALL LAVATORIES. 12. PROVIDE TRUBUNG LAV CURAD I (OR SIMILAR) PROTIECTION FOR PLUMBING LINES UNDER LAVATORIES. 13. FIELD VERIFY IF TRAP PRIMERS FOR FLOOR DRAINS AND INSTALL IN EXISTING FLOOR DRAIN BODIES AND REINSTALL EXISTING WHERE APPLICABLE. 14. PROVIDE NEW WALL CARRIERS AND MOUNTING ACCESSORDIES FOR ALL NEW FIXTURES. 15. CAULK NEW FIXTURES TO FLOOR DRAINS AND INSTALL IN EXISTING VENT TERMINATIONS THROUGH ROOF TO AVOID ANY NEW ROOF WORK. 16. WHERE FOSSIBLE CONFECT TO ROR TO EXISTING VENT PIPING AND REUSE EXISTING VENT TERMINATIONS THROUGH ROOF TO AVOID ANY NEW ROOF WORK.		
 PROVIDE NEW COLD WATER AND HOT WATER ISOLATION VALVES TO ISOLATE EACH BATHROOM GROUP (TYP 3). INSTALL VALVES IN ACCESSIBLE LOCATION OR PROVIDE ACCESS PANEL TO ACCESS VALVES. COORDINATE ACCESS PANEL LOCATION, SIZE, AND COLOR WITH ARCHITECT. MODIFY EXISTING SEWER, VENT, HOT WATER, AND COLD WATER LINES TO ACCOMMODATE NEW FIXTURES. PROVIDE ANCLE STOPS AND ESCUSION PLATES AT LAVATORY AND DRINKING FOUNTAIN DOMESTIC WATER STUB-INS THROUGH WALL. PROVIDE NEW TYPE': A WATER HAMMER ARRESTORS AT THE END OF EACH COLD WATER LINE SERVING TOILETS. SURVEY EXISTING PLUMBING SYSTEMS TO DETERMINE EXISTING PLUMBING MATERIAL TYPES, ALL NEW PIPING MATERIALS SHALL COMPLY WITH CURRENT PLUMBING CODE. PROVIDE NEW SANITARY SEWER WALL CLEANOUTS. CLEANOUTS SHALL BE LOCATED PER APPLICABLE PLUMBING CODES AND SHALL BE COORDINATED WITH THE ARCHITECT. PROVIDE NEW SANITARY SEWER WALL CLEANOUTS. CLEANOUTS SHALL BE LOCATED PER APPLICABLE PLUMBING CODES AND SHALL BE COORDINATED WITH THE ARCHITECT. PROVIDE NEW SANITARY SEWER WALL CLEANOUTS. CLEANOUTS TO MATCH FIXTURES IN COUNCIL CHAMBERS RESTROOM GROUP. CONTRACTOR TO VERIFY EXISTING PLUMBING FIXTURES DURING PRE-BID WALK THRU. ALL FIXTURES TO BE ADA. PROVIDE DRINKING FOUNTAIN TO MATCH COUNCIL CHAMBER SINGLE DRINKING FOUNTAIN WITH BOTTLE FILLER. PROVIDE AND YALVES AT ALL LAVATORIES. PROVIDE AND YALVES AT ALL LAVATORIES. PROVIDE TRUBRO LAV GUARD II (OR SIMILAR) PROTECTION FOR PLUMBING LINES UNDER LAVATORIES. FROVIDE AND YALVES AT ALL LAVATORIES. PROVIDE TRUBRO LAV GUARD II (OR SIMILAR) PROTECTION FOR PLUMBING LINES UNDER LAVATORIES. FROVIDE NEW WALL CARRIERS AND MOUNTING ACCESSORIES FOR ALL NEW FIXTURES. FOOVIDE NEW VALL CARRIERS AND MOUNTING ACCESSORIES FOR ALL NEW FIXTURES. CAULK NEW FIXTURES TO FLOOR DRAINS ARE PRESENT AND OPERABLE. IF NO OPERABLE TRAP PRIMERS ARE PRESENT, PROVIDE TR	Ζ.	
 LOCATION OR PROVIDE ACCESS PANEL TO ACCESS VALVES. COORDINATE ACCESS PANEL LOCATION. SIŻE, AND COLOR WITH ARCHITECT. MODIFY EXISTING SEWER, VENT, HOT WATER, AND COLD WATER LINES TO ACCOMMODATE NEW FIXTURES. PROVIDE ANGLE STOPS AND ESCUSION PLATES AT LAVATORY AND DRINKING FOUNTAIN DOMESTIC WATER STUB-INS THROUGH WALL. PROVIDE NEW TYPE 'A' WATER HAMMER ARRESTORS AT THE END OF EACH COLD WATER LINE SERVING TOILETS. SURVEY EXISTING FUUMBING SYSTEMS TO DETERMINE EXISTING PLUMBING MATERIAL TYPES, ALL NEW PIPING MATERIALS SHALL COMPLY WITH CURRENT PLUMBING CODE. PROVIDE NEW SANITARY SEWER WALL CLEANOUTS. CLEANOUTS SHALL BE LOCATED PER APPLICABLE PLUMBING CODES AND SHALL BE COORDINATED WITH THE ARCHITECT. PROVIDE NEW SANITARY SEWER WALL CLEANOUTS. CLEANOUTS SHALL BE LOCATED PER APPLICABLE PLUMBING CODES AND SHALL BE COORDINATED WITH THE ARCHITECT. PROVIDE NEW SANITARY SEWER WALL CLEANOUTS. CLEANOUTS STOLE TO MATCH FIXTURES IN COUNCIL CHAMBERS RESTROOM GROUP. CONTRACTOR TO VERIFY EXISTING PLUMBING FIXTURES DURING PRE-BID WALK THRU. ALL FIXTURES TO BE ADA. PROVIDE DRINKING FOUNTAIN TO MATCH COUNCIL CHAMBER SINGLE DRINKING FOUNTAIN WITH BOTTLE FILLER. PROVIDE TRUBRO LAV GUARD II (OR SIMILAR) PROTECTION FOR PLUMBING LINES UNDER LAVATORIES. PROVIDE TRUBRO LAV GUARD II (OR SIMILAR) PROTECTION FOR PLUMBING LINES UNDER LAVATORIES. FIELD VERIFY IF TRAP PRIMERS FOR FLOOR DRAINS ARE PRESENT AND OPERABLE. IF NO OPERABLE TANP PRIMERS ARE PRESENT, PROVIDE TRAP GUARDS FOR FLOOR PLONG DRAINS BODIES AND REINSTALL EXISTING WHERE APPLICABLE. FOVIDE TRUBRO LAV GUARD STALL IN EXISTING FLOOR DRAIN BODIES AND REINSTALL EXISTING WHERE APPLICABLE. FOVIDE TRUBRO FOOR WALK. CAULK NEW FIXTURES TO FLOORDYMALL/OUNTER TO ENSURE TICHT SEAL TO MOUNTING SURFACE. WHERE POSSIBLE, CONNECT TO NEW VENT PIPING TO EXISTING VENT PIPING AND REUSE EXISTING VE	2	
 MODIFY EXISTING SEWER, VENT, HOT WATER, AND COLD WATER LINES TO ACCOMMODATE NEW FIXTURES. PROVIDE ANGLE STOPS AND ESCUSION PLATES AT LAVATORY AND DRINKING FOUNTAIN DOMESTIC WATER STUB-INS THROUGH WALL. PROVIDE NEW TYPE 'A' WATER HAMMER ARRESTORS AT THE END OF EACH COLD WATER LINE SERVING TOILETS. SURVEY EXISTING PLUMBING SYSTEMS TO DETERMINE EXISTING PLUMBING MATERIAL TYPES, ALL NEW PIPING MATERIALS SHALL COMPLY WITH CURRENT PLUMBING CODE. PROVIDE NEW SANITARY SEWER WALL CLEANOUTS. CLEANOUTS SHALL BE LOCATED PER APPLICABLE PLUMBING CODES AND SHALL BE COORDINATED WITH THE ARCHITECT. PROVIDE NEW PLUMBING FIXTURES AND AUTOMATIC FLUSH CONTROLS TO MATCH FIXTURES IN COUNCIL CHAMBERS RESTROOM GROUP. CONTRACTOR TO VERIFY EXISTING PLUMBING FIXTURES DURING PRE-BID WALK THRU. ALL FLYTURES TO BE ADA. PROVIDE DRINKING FOUNTAIN TO MATCH COUNCIL CHAMBER SINGLE DRINKING FOUNTAIN WITH BOTTLE FILLER. PROVIDE ASSE 1070 MIXING VALVES AT ALL LAVATORIES. PROVIDE TRUBRO LAV GUARD II (OR SIMILAR) PROTECTION FOR PLUMBING LINES UNDER LAVATORIES. FIELD VERIFY IF TRAP PRIMERS FOR FLOOR DRAINS ARE PRESENT AND OPERABLE. IF NO OPERABLE TRAP PRIMERS ARE PRESENT, PROVIDE TRAP GUARDS FOR FLOOR DRAINS AND INSTALL IN ENSURE TICHT SEAL TO MOUNTING WALL CARRIERS AND AUXISTING FLOOR DRAIN BOILES AND REINSTALL EXISTING WHERE APPLICABLE. FROVIDE NEW WALL CARRIERS AND MOUNTING ACCESSORIES FOR ALL NEW FIXTURES. CAULK NEW FIXTURES TO FLOOR/WALL/COUNTER TO ENSURE TICHT SEAL TO MOUNTING VALUES AND RENUEL CARDE EXISTING VENT TERMINATIONS THROUGH ROOF TO AVOID ANY NEW ROOF WORK. PROVIDE TWO COPIES OF OPERATION AND MAINTENANCE MANUALS FOR ALL PLUMBING FIXTURES. PROVIDE TWO COPIES OF OPERATION AND MAINTENANCE MANUALS FOR ALL PLUMBING FIXTURES. PROVIDE TWO COPIES OF OPERATION AND MAINTENANCE MANUALS FOR ALL PLUMBING FIXTURES. PROVIDE ADEQUATE WALL CLEANOUTS	5.	
 PROVIDE ANGLE STOPS AND ESCUSION PLATES AT LAVATORY AND DRINKING FOUNTAIN DOMESTIC WATER STUB-INS THROUGH WALL. PROVIDE NEW SATYPE 'A' WATER HAMMER ARRESTORS AT THE END OF EACH COLD WATER LINE SERVING TOILETS. SURVEY EXISTING PLUMBING SYSTEMS TO DETERMINE EXISTING PLUMBING MATERIAL TYPES, ALL NEW PIPING MATERIALS SHALL COMPLY WITH CURRENT PLUMBING GODE. PROVIDE NEW SANITARY SEWER WALL CLEANOUTS. CLEANOUTS SHALL BE LOCATED PER APPLICABLE PLUMBING CODES AND SHALL BE COORDINATED WITH THE ARCHITECT. PROVIDE NEW SLAINTERS AND AUTOMATIC FLUSH CONTROLS TO MATCH FIXTURES IN COUNCIL CHAMBERS RESTROOM GROUP. CONTRACTOR TO VERIFY EXISTING PLUMBING FIXTURES DURING PRE-BID WALK THRU. ALL FIXTURES TO BE ADA. PROVIDE DRIVINKING FOUNTAIN TO MATCH COUNCIL CHAMBERS SINGLE DRINKING FOUNTAIN WITH BOTTLE FILLER. PROVIDE ASSE 1070 MIXING VALVES AT ALL LAVATORIES. PROVIDE TRUBRO LAV GUARD II (OR SIMILAR) PROTECTION FOR PLUMBING LINES UNDER LAVATORIES. PROVIDE TRUBRO LAV GUARD II (OR SIMILAR) PROTECTION FOR PLUMBING LINES UNDER LAVATORIES. PROVIDE TRUBRO LAV GUARD II (OR SIMILAR) PROTECTION FOR PLUMBING LINES UNDER LAVATORIES. PROVIDE TRUBRO LAV GUARD II (OR SIMILAR) PROTECTION FOR PLUMBING LINES UNDER LAVATORIES. FLED VERIFY IF TRAP PRIMERS FOR FLOOR DRAINS ARE PRESENT AND OPERABLE. IF NO OPERABLE TRAP PRIMERS ARE PRESENT, PROVIDE TRUBRO LAV GUARDS FOR FLOOR DRAINS AND INSTALL IN EXISTING FLOOR DRAIN BODIES AND REINSTALL EXISTING WHERE APPLICABLE. PROVIDE NEW WALL CARRIERS AND MOUNTING OLEXISTING VENT FIPING AND REUSE EXISTING VENT TERMINATIONS THROUGH ROOF TO AVOID ANY NEW ROOF WORK. RROVIDE EXISTING IN-WALL PLUMBING AS REQUIRED FOR NEW WORK. RROVIDE ADEQUATE WALL CLEANOUTS TO CLEAN PLUMBING LINES PER IPC REQUIREMENTS. PROVIDE ADEQUATE WALL CLEANOUTS TO CLEAN PLUMBING LINES PER IPC REQUIREMENTS. PROVIDE ADEQUATE WAL	л	
 PROVIDE NEW TYPE 'A' WATER HAMMER ARRESTORS AT THE END OF EACH COLD WATER LINE SERVING TOILETS. SURVEY EXISTING PLUMBING SYSTEMS TO DETERMINE EXISTING PLUMBING MATERIAL TYPES, ALL NEW PIPING MATERIALS SHALL COMPLY WITH CURRENT PLUMBING CODE. PROVIDE NEW SANITARY SEWER WALL CLEANOUTS. CLEANOUTS SHALL BE LOCATED PER APPLICABLE PLUMBING CODES AND SHALL BE COORDINATED WITH THE ARCHITECT. PROVIDE NEW PLUMBING FIXTURES AND AUTOMATIC FLUSH CONTROLS TO MATCH FIXTURES IN COUNCIL CHAMBERS RESTROOM GROUP. CONTRATOR TO VERIFY EXISTING PLUMBING FIXTURES DURING PRE-BID WALK THRU. ALL FIXTURES TO BE ADA. PROVIDE ASSE 1070 MIXING VALVES AT ALL LAVATORIES. PROVIDE ASSE 1070 MIXING VALVES AT ALL LAVATORIES. PROVIDE TRUBRO LAV GUARD II (OR SIMILAR) PROTECTION FOR PLUMBING LINES UNDER LAVATORIES. FIELD VERIFY IF TRAP PRIMERS FOR FLOOR DRAINS ARE PRESENT AND OPERABLE. IF NO OPERABLE TRAP PRIMERS ARE PRESENT, PROVIDE TRAP GUARDS FOR FLOOR DRAINS AND INSTALL IN EXISTING FLOOR DRAIN BODIES AND REINSTALL EXISTING WHERE APPLICABLE. PROVIDE NEW WALL CARRIERS AND MOUNTING ACCESSORIES FOR ALL NEW FIXTURES. CAULK NEW FIXTURES TO FLOORWALL/COUNTER TO ENSURE TIGHT SEAL TO MOUNTING SURFACE. WHERE POSSIBLE, CONNECT TO NEW VENT PIPING TO EXISTING VENT PIPING SURFACE. WHERE POSSIBLE, CONNECT TO NEW VENT PIPING TO EXISTING VENT PIPING SURFACE. WREDE TWO COPF WORK. RRROUTE EXISTING IN-WALL PLUMBING AS REQUIRED FOR NEW WORK. RRROUTE SOF OPERATION AND MAINTENANCE MANUALS FOR ALL PLUMBING FIXTURES. PROVIDE ADEQUATE WALL CLEANOUTS TO CLEAN PLUMBING LINES PER IPC REQUIREMENTS. PROVIDE ADEQUATE WALL CLEANOUTS TO CLEAN PLUMBING LINES PER IPC REQUIREMENTS. VALVES SHALL BE LINE SIZE. PIPING IN STALLATION SHALL CONCEALED; EXPOSED PIPING, WHERE NECESSARY, SHALL BE ROUTED AS HIGH AS POSSIBLE AND TIGHT TO WALLS. NOTIFY		
 SURVEY EXISTING PLUMBING SYSTEMS TO DETERMINE EXISTING PLUMBING MATERIAL TYPES, ALL NEW PIPING MATERIALS SHALL COMPLY WITH CURRENT PLUMBING CODE. PROVIDE NEW SANITARY SEWER WALL CLEANOUTS. CLEANOUTS SHALL BE LOCATED PER APPLICABLE PLUMBING CODES AND SHALL BE COORDINATED WITH THE ARCHITECT. PROVIDE NEW PLUMBING FIXTURES AND AUTOMATIC FLUSH CONTROLS TO MATCH FIXTURES IN COUNCIL CHAMBERS RESTROOM GROUP. CONTRACTOR TO VERIFY EXISTING PLUMBING FIXTURES DURING PRE-BID WALK THRU. ALL FIXTURES TO BE ADA. PROVIDE DRINKING FOUNTAIN TO MATCH COUNCIL CHAMBER SINGLE DRINKING FOUNTAIN WITH BOTTLE FILLER. PROVIDE ASSE 1070 MIXING VALVES AT ALL LAVATORIES. PROVIDE TRUBRO LAV GUARD II (OR SIMILAR) PROTECTION FOR PLUMBING LINES UNDER LAVATORIES. FIELD VERIFY IF TRAP PRIMERS FOR FLOOR DRAINS ARE PRESENT AND OPERABLE. IF NO OPERABLE TRAP PRIMERS ARE PRESENT, PROVIDE TRAP GUARDS FOR FLOOR DRAINS AND INSTALL IN EXISTING FLOOR DRAIN BOPERABLE. IF NO OPERABLE TRAP PRIMERS ARE PRESENT, PROVIDE TRAP GUARDS FOR FLOOR DRAINS AND INSTALL IN EXISTING FLOOR DRAIN BODES AND REINSTALL EXISTING WHERE APPLICABLE. CAULK NEW FIXTURES TO FLOOR DRAINS AND INSTALL IN EXISTING FLOOR DRAIN BODES AND REINSTALL EXISTING WHERE APPLICABLE. CAULK NEW FIXTURES TO FLOOR WALL/COUNTER TO ENSURE TIGHT SEAL TO MOUNTING SURFACE. WHERE POSSIBLE, CONNECT TO NEW VENT PIPING TO EXISTING VENT PIPING AND REUSE EXISTING VENT TERMINATIONS THROUGH ROOF TO AVOID ANY NEW ROOF WORK. PROVIDE TWO COPIES OF OPERATION AND MAINTENANCE MANUALS FOR ALL PLUMBING FIXTURES. PROVIDE ADEQUATE WALL CLEANOUTS TO CLEAN PLUMBING LINES PER IPC REQUIREMENTS. PROVIDE ADEQUATE WALL CLEANOUTS TO CLEAN PLUMBING LINES PER IPC REQUIREMENTS. PROVIDE ADEQUATE WALL CLEANOUTS TO CLEAN PLUMBING LINES PER IPC REQUIREMENTS. PROVIDE ADEQUATE WALL CLEANOUTS TO CLEAN PLUMBING LINES PER IPC REQUIREMENTS. P		
 WITH CURRENT PLUMBING CODE. PROVIDE NEW SANITARY SEWER WALL CLEANOUTS. CLEANOUTS SHALL BE LOCATED PER APPLICABLE PLUMBING CODES AND SHALL BE COORDINATED WITH THE ARCHITECT. PROVIDE NEW PLUMBING FIXTURES AND AUTOMATIC FLUSH CONTROLS TO MATCH FIXTURES IN COUNCIL CHAMBERS RESTROOM GROUP. CONTRACTOR TO VERIFY EXISTING PLUMBING FIXTURES DURING PRE-BID WALL FIXTURES TO BE ADA. PROVIDE DRINKING FOUNTAIN TO MATCH COUNCIL CHAMBER SINGLE DRINKING FOUNTAIN WITH BOTTLE FILLER. PROVIDE ASSE 1070 MIXING VALVES AT ALL LAVATORIES. PROVIDE TRUBRO LAV GUARD II (OR SIMILAR) PROTECTION FOR PLUMBING LINES UNDER LAVATORIES. FIELD VERIFY JF TRAP PRIMERS FOR FLOOR DRAINS ARE PRESENT AND OPERABLE. IF NO OPERABLE TRAP PRIMERS ARE PRESENT, PROVIDE TRAP GUARDS FOR FLOOR DRAINS AND INSTALL IN EXISTING FLOOR DRAIN BODIES AND REINSTALL EXISTING WHERE APPLICABLE. PROVIDE NEW WALL CARRIERS AND MOUNTING ACCESSORIES FOR ALL NEW FIXTURES. CALUK NEW FIXTURES TO FLOOR DRAINS AND INSTALL IN EXISTING FLOOR DRAIN BODIES AND REUSE EXISTING WHERE APPLICABLE. WREP GOSSIBLE, CONNECT TO NEW VENT PIPING TO EXISTING VENT PIPING AND REUSE EXISTING VENT TERMINATIONS THROUGH ROOF TO AVOID ANY NEW ROOF WORK. RROVIDE AND RUMALL CLEANOUTS TO CLEAN PLUMBING LINES PER IPC REQUIREMENTS. 		
 PROVIDE NEW SANITARY SEWER WALL CLEANOUTS. CLEANOUTS SHALL BE LOCATED PER APPLICABLE PLUMBING CODES AND SHALL BE COORDINATED WITH THE ARCHITECT. PROVIDE NEW PLUMBING FIXTURES AND AUTOMATIC FLUSH CONTROLS TO MATCH FIXTURES IN COUNCIL CHAMBERS RESTROOM GROUP. CONTRACTOR TO VERIFY EXISTING PLUMBING FIXTURES DURING PRE-BID WALK THRU. ALL FIXTURES TO BE ADA. PROVIDE ASSE 1070 MIXING VALVES AT ALL LAVATORIES. PROVIDE ASSE 1070 MIXING VALVES AT ALL LAVATORIES. PROVIDE TRUBRO LAV GUARD II (OR SIMILAR) PROTECTION FOR PLUMBING LINES UNDER LAVATORIES. FIELD VERIFY IF TRAP PRIMERS FOR FLOOR DRAINS ARE PRESENT AND OPERABLE. IF NO OPERABLE TRAP PRIMERS ARE PRESENT, PROVIDE TRAP GUARDS FOR FLOOR DRAINS AND INSTALL IN EXISTING FLOOR DRAIN BODIES AND REINSTALL EXISTING WHERE APPLICABLE. CAULK NEW FIXTURES TO FLOOR DRAINS AND MOUNTING ACCESSORIES FOR ALL NEW FIXTURES. CAULK NEW FIXTURES TO TO NEW VENT PIPING TO EXISTING VENT PIPING AND REUSE EXISTING VENT TERMINATIONS THROUGH ROOF TO AVOID ANY NEW ROOF WORK. PROVIDE TWO COPIES OF OPERATION AND MAINTENANCE MANUALS FOR ALL PLUMBING FIXTURES. PROVIDE TWO COPIES OF OPERATION AND MAINTENANCE MANUALS FOR ALL PLUMBING FIXTURES. PROVIDE TWO COPIES OF OPERATION AND MAINTENANCE MANUALS FOR ALL PLUMBING FIXTURES. PROVIDE ADEQUATE WALL CLEANOUTS TO CLEAN PLUMBING LINES PER IPC REQUIREMENTS. 	1.	
COORDINATED WITH THE ARCHITECT. 9. PROVIDE NEW PLUMBING FIXTURES AND AUTOMATIC FLUSH CONTROLS TO MATCH FIXTURES IN COUNCIL CHAMBERS RESTROOM GROUP. CONTRACTOR TO VERIFY EXISTING PLUMBING FIXTURES DURING PRE-BID WALK THRU. ALL FIXTURES TO BE ADA. 10. PROVIDE DRINKING FOUNTAIN TO MATCH COUNCIL CHAMBER SINGLE DRINKING FOUNTAIN WITH BOTTLE FILLER. 11. PROVIDE ASSE 1070 MIXING VALVES AT ALL LAVATORIES. 12. PROVIDE TRUBRO LAV GUARD II (OR SIMILAR) PROTECTION FOR PLUMBING LINES UNDER LAVATORIES. 13. FIELD VERIFY IF TRAP PRIMERS FOR FLOOR DRAINS ARE PRESENT AND OPERABLE. IF NO OPERABLE TRAP PRIMERS ARE PRESENT, PROVIDE TRAP GUARDS FOR FLOOR DRAINS AND INSTALL IN EXISTING FLOOR DRAIN BODIES AND REINSTALL EXISTING WHERE APPLICABLE. 14. PROVIDE NEW WALL CARRIERS AND MOUNTING ACCESSORIES FOR ALL NEW FIXTURES. 15. CAULK NEW FIXTURES TO FLOOR/WALL/COUNTER TO ENSURE TIGHT SEAL TO MOUNTING SURFACE. 16. WHERE POSSIBLE, CONNECT TO NEW VENT PIPING TO EXISTING VENT PIPING AND REUSE EXISTING VENT TERMINATIONS THROUGH ROOF TO A/VOID ANY NEW ROOF WORK. 17. REROUTE EXISTING IN-WALL PLUMBING AS REQUIRED FOR NEW WORK. 18. PROVIDE TWO COPIES OF OPERATION AND MAINTENANCE MANUALS FOR ALL PLUMBING FIXTURES. 19. PROVIDE ADEQUATE WALL CLEANOUTS TO CLEAN PLUMBING LINES PER IPC REQUIREMENTS. TOLET RENOVATIONS PLUMBING NOTES: 11. PLUMBING INSTALLATION SHALL COMPLY WITH ALL LOCALLY ADOPTED CODES AND REGULATIONS. 12. VALVES SHALL BE LINE SIZE. 13. PLUMBING INSTALLATION SHALL COMPLY WITH ALL LOCALLY ADOPTED CODES AND REGULATIONS. 14. VALVES SHALL BE LINE SIZE. 15. VALVES SHALL BE LINE SIZE. 16. WHERE PRESENT ON THE SIZE PROVED CONCEALED; EXPOSED PIPING, WHERE NECESSARY, SHALL BE ROUTED AS HIGH AS POSSIBLE AND TIGHT TO WALLS. NOTIFY ARCHITECT PRIOR TO INSTALLATION IF EXPOSED PIPING IS REQUIRED. 17. AND TIGHT TO WALLS. NOTIFY ARCHITECT PRIOR TO INSTALLATION IF EXPOSED PIPING IS REQUIRED.	8	
 PROVIDE NEW PLUMBING FIXTURES AND AUTOMATIC FLUSH CONTROLS TO MATCH FIXTURES IN COUNCIL CHAMBERS RESTROOM GROUP. CONTRACTOR TO VERIFY EXISTING PLUMBING FIXTURES DURING PRE-BID WALK THRU. ALL FIXTURES TO BE ADA. PROVIDE DRINKING FOUNTAIN TO MATCH COUNCIL CHAMBER SINGLE DRINKING FOUNTAIN WITH BOTTLE FILLER. PROVIDE ASSE 1070 MIXING VALVES AT ALL LAVATORIES. PROVIDE TRUBRO LAV GUARD II (OR SIMILAR) PROTECTION FOR PLUMBING LINES UNDER LAVATORIES. FIELD VERIFY IF TRAP PRIMERS FOR FLOOR DRAINS ARE PRESENT AND OPERABLE. IF NO OPERABLE TRAP PRIMERS ARE PRESENT, PROVIDE TRAP GUARDS FOR FLOOR DRAINS AND INSTALL IN EXISTING FLOOR DRAIN BODIES AND REINSTALL EXISTING WHERE APPLICABLE. PROVIDE NEW WALL CARRIERS AND MOUNTING ACCESSORIES FOR ALL NEW FIXTURES. CAULK NEW FIXTURES TO FLOORWALL/COUNTER TO ENSURE TIGHT SEAL TO MOUNTING SURFACE. WHERE POSSIBLE, CONNECT TO NEW VENT PIPING TO EXISTING VENT PIPING AND REUSE EXISTING VENT TERMINATIONS THROUGH ROOF TO AVOID ANY NEW ROOF WORK. REROUTE EXISTING IN-WALL PLUMBING AS REQUIRED FOR NEW WORK. PROVIDE TWO COPIES OF OPERATION AND MAINTENANCE MANUALS FOR ALL PLUMBING FIXTURES. PROVIDE TWO COPIES OF OPERATION AND MAINTENANCE MANUALS FOR ALL PLUMBING FIXTURES. PROVIDE ADEQUATE WALL CLEANOUTS TO CLEAN PLUMBING LINES PER IPC REQUIREMENTS. TOLIET RENOVATIONS PLUMBING NOTES: PLUMBING INSTALLATION SHALL COMPLY WITH ALL LOCALLY ADOPTED CODES AND REGULATIONS. VALVES SHALL BE LINE SIZE. PLUMBING IN FINISHED AREAS SHALL BE ROUTED CONCEALED; EXPOSED PIPING, WHERE NECESSARY, SHALL BE ROUTED AS HIGH AS POSSIBLE AND TIGHT TO WALLS. NOTIFY ARCHITECT PRIOR TO INSTALLATION IF EXPOSED PIPING IS REQUIRED. INSULATE PIPING ROUTED IN EXTERIOR BUILDING WALLS WITH MINIMUM 2" BLACK CLOSED CELL INSULATION TO PREVENT FREEZING. ALL COLD 	0.	
 CONTRACTOR TO VERIFY EXISTING PLUMBING FIXTURES DURING PRE-BID WALK THRU. ALL FIXTURES TO BE ADA. PROVIDE DRINKING FOUNTAIN TO MATCH COUNCIL CHAMBER SINGLE DRINKING FOUNTAIN WITH BOTTLE FILLER. PROVIDE ASSE 1070 MIXING VALVES AT ALL LAVATORIES. PROVIDE TRUBRO LAV GUARD II (OR SIMILAR) PROTECTION FOR PLUMBING LINES UNDER LAVATORIES. FIELD VERIFY IF TRAP PRIMERS FOR FLOOR DRAINS ARE PRESENT AND OPERABLE. IF NO OPERABLE TRAP PRIMERS ARE PRESENT, PROVIDE TRAP GUARDS FOR FLOOR DRAIND INSTALL IN EXISTING FLOOR DRAIN BODIES AND REINSTALL EXISTING WHERE APPLICABLE. PROVIDE NEW WALL CARRIERS AND MOUNTING ACCESSORIES FOR ALL NEW FIXTURES. CAULK NEW FIXTURES TO FLOOROWALL/COUNTER TO ENSURE TIGHT SEAL TO MOUNTING SURFACE. CHURE POSSIBLE, CONNECT TO NEW VENT PIPING TO EXISTING VENT PIPING AND REUSE EXISTING VENT TERMINATIONS THROUGH ROOF TO AVOID ANY NEW ROOF WORK. REROUTE EXISTING IN-WALL PLUMBING AS REQUIRED FOR NEW WORK. REROUTE ADEQUATE WALL CLEANOUTS TO CLEAN PLUMBING LINES PER IPC REQUIREMENTS. TOILET RENOVATIONS PLUMBING NOTES: PROVIDE ADEQUATE WALL CLEANOUTS TO CLEAN PLUMBING LINES PER IPC REQUIREMENTS. TOLLET RENOVATIONS SHALL COMPLY WITH ALL LOCALLY ADOPTED CODES AND REGULATIONS. VALVES SHALL BE LINE SIZE. PIPING IN FINISHED AREAS SHALL BE ROUTED CONCEALED; EXPOSED PIPING, WHERE NECESSARY, SHALL BE ROUTED AS HIGH AS POSSIBLE AND TIGH TO WALLS. NOTIFY ARCHITECT PRIOR TO INSTALLATION IF EXPOSED PIPING SI REQUIRED. INSULATE PIPING ROUTED IN EXTERIOR BUILDING WALLS WITH MINIMUM 2" BLACK CLOSED CELL INSULATION TO PREVENT FREEZING. ALL COLD 	9.	
 PROVIDE DRINKING FOUNTAIN TO MATCH COUNCIL CHAMBER SINGLE DRINKING FOUNTAIN WITH BOTTLE FILLER. PROVIDE ASSE 1070 MIXING VALVES AT ALL LAVATORIES. PROVIDE TRUBRO LAV GUARD II (OR SIMILAR) PROTECTION FOR PLUMBING LINES UNDER LAVATORIES. FIELD VERIFY IF TRAP PRIMERS FOR FLOOR DRAINS ARE PRESENT AND OPERABLE. IF NO OPERABLE TRAP PRIMERS ARE PRESENT, PROVIDE TRAP GUARDS FOR FLOOR DRAINS AND INSTALL IN EXISTING FLOOR DRAIN BODIES AND REINSTALL EXISTING WHERE APPLICABLE. PROVIDE NEW WALL CARRIERS AND MOUNTING ACCESSORIES FOR ALL NEW FIXTURES. CAULK NEW FIXTURES TO FLOOR/WALL/COUNTER TO ENSURE TIGHT SEAL TO MOUNTING SURFACE. WHERE POSSIBLE, CONNECT TO NEW VENT PIPING TO EXISTING VENT PIPING AND REUSE EXISTING VENT TERMINATIONS THROUGH ROOF TO AVOID ANY NEW ROOF WORK. PROVIDE TWO COPIES OF OPERATION AND MAINTENANCE MANUALS FOR ALL PLUMBING FIXTURES. PROVIDE TWO COPIES OF OPERATION AND MAINTENANCE MANUALS FOR ALL PLUMBING FIXTURES. PROVIDE ADEQUATE WALL CLEANOUTS TO CLEAN PLUMBING LINES PER IPC REQUIREMENTS. TOILET RENOVATIONS PLUMBING NOTES: PULMBING INSTALLATION SHALL COMPLY WITH ALL LOCALLY ADOPTED CODES AND REGULATIONS. VALVES SHALL BE LINE SIZE. PIPING IN FINISHED AREAS SHALL BE ROUTED CONCEALED; EXPOSED PIPING, WHERE NECESSARY, SHALL BE ROUTED AS HIGH AS POSSIBLE AND TIG IN FINISHED AREAS SHALL BE ROUTED CONCEALED; EXPOSED PIPING, WHERE NECESSARY, SHALL BE ROUTED AS HIGH AS POSSIBLE AND TIG IN FINISHED AREAS SHALL BE ROUTED CONCEALED; EXPOSED PIPING IS REQUIRED. INSULATE PIPING ROUTED IN EXTERIOR BUILDING WALLS WITH MINIMUM 2" BLACK CLOSED CELL INSULATION TO PREVENT FREEZING. ALL COLD	•.	
 PROVIDE TRUBRO LAV GUARD II (OR SIMILAR) PROTECTION FOR PLUMBING LINES UNDER LAVATORIES. FIELD VERIFY IF TRAP PRIMERS FOR FLOOR DRAINS ARE PRESENT AND OPERABLE. IF NO OPERABLE TRAP PRIMERS ARE PRESENT, PROVIDE TRAP GUARDS FOR FLOOR DRAINS AND INSTALL IN EXISTING FLOOR DRAIN BODIES AND REINSTALL EXISTING WHERE APPLICABLE. PROVIDE NEW WALL CARRIERS AND MOUNTING ACCESSORIES FOR ALL NEW FIXTURES. CAULK NEW FIXTURES TO FLOOR/WALL/COUNTER TO ENSURE TIGHT SEAL TO MOUNTING SURFACE. WHERE POSSIBLE, CONNECT TO NEW VENT PIPING TO EXISTING VENT PIPING AND REUSE EXISTING VENT TERMINATIONS THROUGH ROOF TO AVOID ANY NEW ROOF WORK. REROUTE EXISTING IN-WALL PLUMBING AS REQUIRED FOR NEW WORK. PROVIDE TWO COPIES OF OPERATION AND MAINTENANCE MANUALS FOR ALL PLUMBING FIXTURES. PROVIDE ADEQUATE WALL CLEANOUTS TO CLEAN PLUMBING LINES PER IPC REQUIREMENTS. TOILET RENOVATIONS PLUMBING NOTES: 1. PLUMBING INSTALLATION SHALL COMPLY WITH ALL LOCALLY ADOPTED CODES AND REGULATIONS. 2. VALVES SHALL BE LINE SIZE. 3. PIPING IN FINISHED AREAS SHALL BE ROUTED CONCEALED; EXPOSED PIPING, WHERE NECESSARY, SHALL BE ROUTED AS HIGH AS POSSIBLE AND TIGHT TO WALLS. NOTIFY ARCHITECT PRIOR TO INSTALLATION IF EXPOSED PIPING IS REQUIRED. 4. INSULATE PIPING ROUTED IN EXTERIOR BUILDING WALLS WITH MINIMUM 2" BLACK CLOSED CLL INSULATION TO PREVENT FREEZING. ALL COLD	10.	
 FIELD VERIFY IF TRAP PRIMERS FOR FLOOR ÓRAINS ARE PRESENT AND OPERABLE. IF NO OPERABLE TRAP PRIMERS ARE PRESENT, PROVIDE TRAP GUARDS FOR FLOOR DRAINS AND INSTALL IN EXISTING FLOOR DRAIN BODIES AND REINSTALL EXISTING WHERE APPLICABLE. PROVIDE NEW WALL CARRIERS AND MOUNTING ACCESSORIES FOR ALL NEW FIXTURES. CAULK NEW FIXTURES TO FLOOR/WALL/COUNTER TO ENSURE TIGHT SEAL TO MOUNTING SURFACE. WHERE POSSIBLE, CONNECT TO NEW VENT PIPING TO EXISTING VENT PIPING AND REUSE EXISTING VENT TERMINATIONS THROUGH ROOF TO AVOID ANY NEW ROOF WORK. REROUTE EXISTING IN-WALL PLUMBING AS REQUIRED FOR NEW WORK. PROVIDE TWO COPIES OF OPERATION AND MAINTENANCE MANUALS FOR ALL PLUMBING FIXTURES. PROVIDE ADEQUATE WALL CLEANOUTS TO CLEAN PLUMBING LINES PER IPC REQUIREMENTS. TOILET RENOVATIONS PLUMBING NOTES: PLUMBING INSTALLATION SHALL COMPLY WITH ALL LOCALLY ADOPTED CODES AND REGULATIONS. VALVES SHALL BE LINE SIZE. PIPING IN FINISHED AREAS SHALL BE ROUTED CONCEALED; EXPOSED PIPING, WHERE NECESSARY, SHALL BE ROUTED AS HIGH AS POSSIBLE AND TIGHT TO WALLS. NOTFY ARCHITECT PRIOR TO INSTALLATION IF EXPOSED PIPING IS REQUIRED. INSULATE PIPING ROUTED IN EXTERIOR BUILDING WALLS WITH MINIMUM 2" BLACK CLOSED CELL INSULATION TO PREVENT FREEZING. ALL COLD	11.	PROVIDE ASSE 1070 MIXING VALVES AT ALL LAVATORIES.
 TRAP GUARDS FOR FLOOR DRAINS AND INSTALL IN EXISTING FLOOR DRAIN BODIES AND REINSTALL EXISTING WHERE APPLICABLE. 14. PROVIDE NEW WALL CARRIERS AND MOUNTING ACCESSORIES FOR ALL NEW FIXTURES. 15. CAULK NEW FIXTURES TO FLOOR/WALL/COUNTER TO ENSURE TIGHT SEAL TO MOUNTING SURFACE. 16. WHERE POSSIBLE, CONNECT TO NEW VENT PIPING TO EXISTING VENT PIPING AND REUSE EXISTING VENT TERMINATIONS THROUGH ROOF TO AVOID ANY NEW ROOF WORK. 17. REROUTE EXISTING IN-WALL PLUMBING AS REQUIRED FOR NEW WORK. 18. PROVIDE TWO COPIES OF OPERATION AND MAINTENANCE MANUALS FOR ALL PLUMBING FIXTURES. 19. PROVIDE ADEQUATE WALL CLEANOUTS TO CLEAN PLUMBING LINES PER IPC REQUIREMENTS. TOILET RENOVATIONS PLUMBING NOTES: 1. PLUMBING INSTALLATION SHALL COMPLY WITH ALL LOCALLY ADOPTED CODES AND REGULATIONS. 2. VALVES SHALL BE LINE SIZE. 3. PIPING IN FINISHED AREAS SHALL BE ROUTED CONCEALED; EXPOSED PIPING, WHERE NECESSARY, SHALL BE ROUTED AS HIGH AS POSSIBLE AND TIGHT TO WALLS. NOTIFY ARCHITECT PRIOR TO INSTALLATION IF EXPOSED PIPING IS REQUIRED. 4. INSULATE PIPING ROUTED IN EXTERIOR BUILDING WALLS WITH MINIMUM 2" BLACK CLOSED CELL INSULATION TO PREVENT FREEZING. ALL COLD	12.	PROVIDE TRUBRO LAV GUARD II (OR SIMILAR) PROTECTION FOR PLUMBING LINES UNDER LAVATORIES.
 PROVIDE NEW WALL CARRIERS AND MOUNTING ACCESSORIES FOR ALL NEW FIXTURES. CAULK NEW FIXTURES TO FLOOR/WALL/COUNTER TO ENSURE TIGHT SEAL TO MOUNTING SURFACE. WHERE POSSIBLE, CONNECT TO NEW VENT PIPING TO EXISTING VENT PIPING AND REUSE EXISTING VENT TERMINATIONS THROUGH ROOF TO AVOID ANY NEW ROOF WORK. PROVIDE EXISTING IN-WALL PLUMBING AS REQUIRED FOR NEW WORK. PROVIDE TWO COPIES OF OPERATION AND MAINTENANCE MANUALS FOR ALL PLUMBING FIXTURES. PROVIDE ADEQUATE WALL CLEANOUTS TO CLEAN PLUMBING LINES PER IPC REQUIREMENTS. TOILET RENOVATIONS PLUMBING NOTES: PLUMBING INSTALLATION SHALL COMPLY WITH ALL LOCALLY ADOPTED CODES AND REGULATIONS. VALVES SHALL BE LINE SIZE. PIPING IN FINISHED AREAS SHALL BE ROUTED CONCEALED; EXPOSED PIPING, WHERE NECESSARY, SHALL BE ROUTED AS HIGH AS POSSIBLE AND TIGHT TO WALLS. NOTIFY ARCHITECT PRIOR TO INSTALLATION IF EXPOSED PIPING IS REQUIRED. INSULATE PIPING ROUTED IN EXTERIOR BUILDING WALLS WITH MINIMUM 2" BLACK CLOSED CELL INSULATION TO PREVENT FREEZING. ALL COLD 	13.	FIELD VERIFY IF TRAP PRIMERS FOR FLOOR DRAINS ARE PRESENT AND OPERABLE. IF NO OPERABLE TRAP PRIMERS ARE PRESENT, PROVIDE
 CAULK NEW FIXTURES TO FLOOR/WALL/COUNTER TO ENSURE TIGHT SEAL TO MOUNTING SURFACE. WHERE POSSIBLE, CONNECT TO NEW VENT PIPING TO EXISTING VENT PIPING AND REUSE EXISTING VENT TERMINATIONS THROUGH ROOF TO AVOID ANY NEW ROOF WORK. REROUTE EXISTING IN-WALL PLUMBING AS REQUIRED FOR NEW WORK. PROVIDE TWO COPIES OF OPERATION AND MAINTENANCE MANUALS FOR ALL PLUMBING FIXTURES. PROVIDE ADEQUATE WALL CLEANOUTS TO CLEAN PLUMBING LINES PER IPC REQUIREMENTS. TOILET RENOVATIONS PLUMBING NOTES: PLUMBING INSTALLATION SHALL COMPLY WITH ALL LOCALLY ADOPTED CODES AND REGULATIONS. VALVES SHALL BE LINE SIZE. PIPING IN FINISHED AREAS SHALL BE ROUTED CONCEALED; EXPOSED PIPING, WHERE NECESSARY, SHALL BE ROUTED AS HIGH AS POSSIBLE AND TIGHT TO WALLS. NOTIFY ARCHITECT PRIOR TO INSTALLATION IF EXPOSED PIPING IS REQUIRED. INSULATE PIPING ROUTED IN EXTERIOR BUILDING WALLS WITH MINIMUM 2" BLACK CLOSED CELL INSULATION TO PREVENT FREEZING. ALL COLD 		TRAP GUARDS FOR FLOOR DRAINS AND INSTALL IN EXISTING FLOOR DRAIN BODIES AND REINSTALL EXISTING WHERE APPLICABLE.
 WHERE POSSIBLE, CONNECT TO NEW VENT PIPING TO EXISTING VENT PIPING AND REUSE EXISTING VENT TERMINATIONS THROUGH ROOF TO AVOID ANY NEW ROOF WORK. REROUTE EXISTING IN-WALL PLUMBING AS REQUIRED FOR NEW WORK. PROVIDE TWO COPIES OF OPERATION AND MAINTENANCE MANUALS FOR ALL PLUMBING FIXTURES. PROVIDE ADEQUATE WALL CLEANOUTS TO CLEAN PLUMBING LINES PER IPC REQUIREMENTS. TOILET RENOVATIONS PLUMBING NOTES: PLUMBING INSTALLATION SHALL COMPLY WITH ALL LOCALLY ADOPTED CODES AND REGULATIONS. VALVES SHALL BE LINE SIZE. PIPING IN FINISHED AREAS SHALL BE ROUTED CONCEALED; EXPOSED PIPING, WHERE NECESSARY, SHALL BE ROUTED AS HIGH AS POSSIBLE AND TIGHT TO WALLS. NOTIFY ARCHITECT PRIOR TO INSTALLATION IF EXPOSED PIPING IS REQUIRED. INSULATE PIPING ROUTED IN EXTERIOR BUILDING WALLS WITH MINIMUM 2" BLACK CLOSED CELL INSULATION TO PREVENT FREEZING. ALL COLD 		
AVOID ANY NEW ROOF WORK. 17. REROUTE EXISTING IN-WALL PLUMBING AS REQUIRED FOR NEW WORK. 18. PROVIDE TWO COPIES OF OPERATION AND MAINTENANCE MANUALS FOR ALL PLUMBING FIXTURES. 19. PROVIDE ADEQUATE WALL CLEANOUTS TO CLEAN PLUMBING LINES PER IPC REQUIREMENTS. TOILET RENOVATIONS PLUMBING NOTES: 1. PLUMBING INSTALLATION SHALL COMPLY WITH ALL LOCALLY ADOPTED CODES AND REGULATIONS. 2. VALVES SHALL BE LINE SIZE. 3. PIPING IN FINISHED AREAS SHALL BE ROUTED CONCEALED; EXPOSED PIPING, WHERE NECESSARY, SHALL BE ROUTED AS HIGH AS POSSIBLE AND TIGHT TO WALLS. NOTIFY ARCHITECT PRIOR TO INSTALLATION IF EXPOSED PIPING IS REQUIRED. 4. INSULATE PIPING ROUTED IN EXTERIOR BUILDING WALLS WITH MINIMUM 2" BLACK CLOSED CELL INSULATION TO PREVENT FREEZING. ALL COLD		
 17. REROUTE EXISTING IN-WALL PLUMBING AS REQUIRED FOR NEW WORK. 18. PROVIDE TWO COPIES OF OPERATION AND MAINTENANCE MANUALS FOR ALL PLUMBING FIXTURES. 19. PROVIDE ADEQUATE WALL CLEANOUTS TO CLEAN PLUMBING LINES PER IPC REQUIREMENTS. TOILET RENOVATIONS PLUMBING NOTES: PLUMBING INSTALLATION SHALL COMPLY WITH ALL LOCALLY ADOPTED CODES AND REGULATIONS. VALVES SHALL BE LINE SIZE. PIPING IN FINISHED AREAS SHALL BE ROUTED CONCEALED; EXPOSED PIPING, WHERE NECESSARY, SHALL BE ROUTED AS HIGH AS POSSIBLE AND TIGHT TO WALLS. NOTIFY ARCHITECT PRIOR TO INSTALLATION IF EXPOSED PIPING IS REQUIRED. INSULATE PIPING ROUTED IN EXTERIOR BUILDING WALLS WITH MINIMUM 2" BLACK CLOSED CELL INSULATION TO PREVENT FREEZING. ALL COLD 	16.	
 PROVIDE TWO COPIES OF OPERATION AND MAINTENANCE MANUALS FOR ALL PLUMBING FIXTURES. PROVIDE ADEQUATE WALL CLEANOUTS TO CLEAN PLUMBING LINES PER IPC REQUIREMENTS. TOILET RENOVATIONS PLUMBING NOTES: PLUMBING INSTALLATION SHALL COMPLY WITH ALL LOCALLY ADOPTED CODES AND REGULATIONS. VALVES SHALL BE LINE SIZE. PIPING IN FINISHED AREAS SHALL BE ROUTED CONCEALED; EXPOSED PIPING, WHERE NECESSARY, SHALL BE ROUTED AS HIGH AS POSSIBLE AND TIGHT TO WALLS. NOTIFY ARCHITECT PRIOR TO INSTALLATION IF EXPOSED PIPING IS REQUIRED. INSULATE PIPING ROUTED IN EXTERIOR BUILDING WALLS WITH MINIMUM 2" BLACK CLOSED CELL INSULATION TO PREVENT FREEZING. ALL COLD 		
 PROVIDE ADEQUATE WALL CLEANOUTS TO CLEAN PLUMBING LINES PER IPC REQUIREMENTS. TOILET RENOVATIONS PLUMBING NOTES: PLUMBING INSTALLATION SHALL COMPLY WITH ALL LOCALLY ADOPTED CODES AND REGULATIONS. VALVES SHALL BE LINE SIZE. PIPING IN FINISHED AREAS SHALL BE ROUTED CONCEALED; EXPOSED PIPING, WHERE NECESSARY, SHALL BE ROUTED AS HIGH AS POSSIBLE AND TIGHT TO WALLS. NOTIFY ARCHITECT PRIOR TO INSTALLATION IF EXPOSED PIPING IS REQUIRED. INSULATE PIPING ROUTED IN EXTERIOR BUILDING WALLS WITH MINIMUM 2" BLACK CLOSED CELL INSULATION TO PREVENT FREEZING. ALL COLD 		
 PLUMBING INSTALLATION SHALL COMPLY WITH ALL LOCALLY ADOPTED CODES AND REGULATIONS. VALVES SHALL BE LINE SIZE. PIPING IN FINISHED AREAS SHALL BE ROUTED CONCEALED; EXPOSED PIPING, WHERE NECESSARY, SHALL BE ROUTED AS HIGH AS POSSIBLE AND TIGHT TO WALLS. NOTIFY ARCHITECT PRIOR TO INSTALLATION IF EXPOSED PIPING IS REQUIRED. INSULATE PIPING ROUTED IN EXTERIOR BUILDING WALLS WITH MINIMUM 2" BLACK CLOSED CELL INSULATION TO PREVENT FREEZING. ALL COLD 		
 PLUMBING INSTALLATION SHALL COMPLY WITH ALL LOCALLY ADOPTED CODES AND REGULATIONS. VALVES SHALL BE LINE SIZE. PIPING IN FINISHED AREAS SHALL BE ROUTED CONCEALED; EXPOSED PIPING, WHERE NECESSARY, SHALL BE ROUTED AS HIGH AS POSSIBLE AND TIGHT TO WALLS. NOTIFY ARCHITECT PRIOR TO INSTALLATION IF EXPOSED PIPING IS REQUIRED. INSULATE PIPING ROUTED IN EXTERIOR BUILDING WALLS WITH MINIMUM 2" BLACK CLOSED CELL INSULATION TO PREVENT FREEZING. ALL COLD 	19.	PROVIDE ADEQUATE WALL CLEANOUTS TO CLEAN PLUMBING LINES PER IPC REQUIREMENTS.
 PLUMBING INSTALLATION SHALL COMPLY WITH ALL LOCALLY ADOPTED CODES AND REGULATIONS. VALVES SHALL BE LINE SIZE. PIPING IN FINISHED AREAS SHALL BE ROUTED CONCEALED; EXPOSED PIPING, WHERE NECESSARY, SHALL BE ROUTED AS HIGH AS POSSIBLE AND TIGHT TO WALLS. NOTIFY ARCHITECT PRIOR TO INSTALLATION IF EXPOSED PIPING IS REQUIRED. INSULATE PIPING ROUTED IN EXTERIOR BUILDING WALLS WITH MINIMUM 2" BLACK CLOSED CELL INSULATION TO PREVENT FREEZING. ALL COLD 	_	
 PLUMBING INSTALLATION SHALL COMPLY WITH ALL LOCALLY ADOPTED CODES AND REGULATIONS. VALVES SHALL BE LINE SIZE. PIPING IN FINISHED AREAS SHALL BE ROUTED CONCEALED; EXPOSED PIPING, WHERE NECESSARY, SHALL BE ROUTED AS HIGH AS POSSIBLE AND TIGHT TO WALLS. NOTIFY ARCHITECT PRIOR TO INSTALLATION IF EXPOSED PIPING IS REQUIRED. INSULATE PIPING ROUTED IN EXTERIOR BUILDING WALLS WITH MINIMUM 2" BLACK CLOSED CELL INSULATION TO PREVENT FREEZING. ALL COLD 		
 VALVES SHALL BE LINE SIZE. PIPING IN FINISHED AREAS SHALL BE ROUTED CONCEALED; EXPOSED PIPING, WHERE NECESSARY, SHALL BE ROUTED AS HIGH AS POSSIBLE AND TIGHT TO WALLS. NOTIFY ARCHITECT PRIOR TO INSTALLATION IF EXPOSED PIPING IS REQUIRED. INSULATE PIPING ROUTED IN EXTERIOR BUILDING WALLS WITH MINIMUM 2" BLACK CLOSED CELL INSULATION TO PREVENT FREEZING. ALL COLD 	то	LET RENOVATIONS PLUMBING NOTES:
 VALVES SHALL BE LINE SIZE. PIPING IN FINISHED AREAS SHALL BE ROUTED CONCEALED; EXPOSED PIPING, WHERE NECESSARY, SHALL BE ROUTED AS HIGH AS POSSIBLE AND TIGHT TO WALLS. NOTIFY ARCHITECT PRIOR TO INSTALLATION IF EXPOSED PIPING IS REQUIRED. INSULATE PIPING ROUTED IN EXTERIOR BUILDING WALLS WITH MINIMUM 2" BLACK CLOSED CELL INSULATION TO PREVENT FREEZING. ALL COLD 		
 PIPING IN FINISHED AREAS SHALL BE ROUTED CONCEALED; EXPOSED PIPING, WHERE NECESSARY, SHALL BE ROUTED AS HIGH AS POSSIBLE AND TIGHT TO WALLS. NOTIFY ARCHITECT PRIOR TO INSTALLATION IF EXPOSED PIPING IS REQUIRED. INSULATE PIPING ROUTED IN EXTERIOR BUILDING WALLS WITH MINIMUM 2" BLACK CLOSED CELL INSULATION TO PREVENT FREEZING. ALL COLD 		
AND TIGHT TO WALLS. NOTIFY ARCHITECT PRIOR TO INSTALLATION IF EXPOSED PIPING IS REQUIRED. 4. INSULATE PIPING ROUTED IN EXTERIOR BUILDING WALLS WITH MINIMUM 2" BLACK CLOSED CELL INSULATION TO PREVENT FREEZING. ALL COLD		
4. INSULATE PIPING ROUTED IN EXTERIOR BUILDING WALLS WITH MINIMUM 2" BLACK CLOSED CELL INSULATION TO PREVENT FREEZING. ALL COLD	3.	
	٨	
	4.	WATER LINES SHALL BE INSULATED WITH MINIMUM OF 3/4" CLOSED CELL INSULATION WITH VAPOR BARRIER. ALL HOT WATER AND HOT WATER

COORDINATE PIPE ROUTING AWAY FROM ELECTRICAL PANELS. DO NOT ROUTE PIPING OVER ELECTRICAL PANELS.

COORDINATE ALL ROOF AND WALL PENETRATIONS WITH OTHER TRADES. ENSURE VENT TERMINATIONS ARE NOT WITHIN 10' OF AIR INTAKES

DRAINAGE AND VENT SYSTEMS SHALL BE PRESSURE TESTED WITH WATER OR AIR.). ALL PENETRATIONS OF FLOOR/CEILING/WALL ASSEMBLIES SHALL BE FIRE STOPPED IN ACCORDANCE WITH LOCALLY ADOPTED BUILDING

11. ALL DRY VENTS SHALL RISE VERTICALLY TO A MINIMUM OF 6 INCHES ABOVE THE FLOOD RIM OF THE HIGHEST TRAP OR TRAPPED FIXTURE BEING

13. PROVIDE SEWER CLEANOUTS AT LOCATIONS AND WITH CLEARANCES REQUIRED BY CODE, NOT EXCEEDING 50' IN HORIZONTAL RUNS AND AT EACH CHANGE OF DIRECTION GREATER THAN 45 DEGREES.

14. CAULK AROUND ALL FIXTURES TO SEAL BETWEEN FIXTURE AND FLOOR OR WALL.

16. SLOPE VENT PIPING AT 1/4" PER FOOT GRADED TO DRIP BACK TO SOIL OR WASTE PIPE BY GRAVITY.

BID ALTERNATE NO. 1: POLICE DEPARTMENT SANITARY SEWER IMPROVEMENTS

PLUMBING FIXTURE SCHEDULE

PROVIDE WATER LINE ISOLATION VALUES AT HOT AND COLD DOMESTIC WATERLINES FOR EACH RESTROOM GROUP TYPICAL.

PROVIDE MANU RESTROOMS T	JAL (M) OPERATED AT POLICE DEPARTMENT/PD AND AUTOMATIC (A) OPERATED CONTROLS AT NW 1ST FLOOR CITY YPICAL
LAV (M)	AMERICAN STANDARD OVALYN UNDERCOUNTER SINK (WHITE) 0495.221.020 WHT UNDERCNTR LAV17-1/8 X 14-1/8 SINK DELTA LAVATORY FAUCETS; 252929LF-LGHDF CHROME LAV FAUCET DEARBORN BRASS; 760-1 1-1/4X6 CAST GRID DRAIN3700-6PC B-0899 MECHANICAL MIXING VALVE; 25903 MIX VLV 3/8" COMPRESSION LFOLD MIX-60-A MANUAL MIX
	AMERICAN STANDARD FLOOR MOUNT MADERA FLOWISE 16 1/2" HEIGHT ELONGATED FLUSHOMETER TOILET (WHITE WATER CLOSET; 3043.001 ELONGATED BOWLY ONLY, TOP SPUD SLOAN MANUAL FLUSHOMETER; 3080053 111-XL REGAL FV ADA1.6 CLOS FLUSH VALVE COMMERCIAL HEAVY-DUTY TOILET SEAT FRONT (NO COVER)
WCF (M)	AMERICAN STANDARD FLOOR MOUNT MADERA FLOWISE 15" HEIGHT ELONGATED FLUSHOMETER TOILET (WHITE) WATER CLOSET; 2234.001 ELONGATED BOWLY ONLY, TOP SPUD SLOAN MANUAL FLUSHOMETER; 3080053 111-XL REGAL FV ADA1.6 CLOS FLUSH VALVE COMMERCIAL HEAVY-DUTY TOILET SEAT FRONT (NO COVER)
UR (M)	AMERICAN STANDARD WASHBROOK FLOWISE UNIVERSAL URINAL (WHITE) 6590.001.020 WHT WSHBRK RUINALWASHBROOK SLOAN MANUAL FLUSHOMETERE; 3082653 186-XL REGAL FLSH VLV1.5 URINAL FLUSH VALVE SMITH MFG. CO.; 0637.M32 URINAL CARRIER W/ BOTTOM BEARING PLATE AND 50" UPRT
LAV (A)	AMERICAN STANDARD OVALYN UNDERCOUNTER SINK (WHITE) 0495.221.020 WHT UNDERCNTR LAV17-1/8 X 14-1/8 SINK AMERICAN STANDARD; SELECTRONIC PROXIMITY FAUCET 605X.10X WITH POWER KIT; CHROME DEARBORN BRASS; 760-1 1-1/4X6 CAST GRID DRAIN 3700-6PC B-0899 MECHANICAL MIXING VALVE; 25903 MIX VLV 3/8" COMPRESSION LFOLD MIX-60-A MANUAL MIX
	AMERICAN STANDARD FLOOR MOUNT MADERA FLOWISE 16 1/2" HEIGHT ELONGATED FLUSHOMETER TOILET (WHITE WATER CLOSET; 3043.001 ELONGATED BOWLY ONLY, TOP SPUD SLOAN MANUAL FLUSHOMETER; 3080053 111-XL REGAL FV ADA1.6 CLOS FLUSH VALVE WITH REGAL 111 SMO BATTERY-POWERED SIDE-MOUNT OPERATOR SENSOR FLUSHOMETER COMMERCIAL HEAVY-DUTY TOILET SEAT FRONT (NO COVER)
WCF (A)	AMERICAN STANDARD FLOOR MOUNT MADERA FLOWISE 15" HEIGHT ELONGATED FLUSHOMETER TOILET (WHITE) WATER CLOSET; 2234.001 ELONGATED BOWLY ONLY, TOP SPUD SLOAN MANUAL FLUSHOMETER; 3080053 111-XL REGAL FV ADA1.6 CLOS FLUSH VALVE WITH REGAL 111 SMO BATTERY-POWERED SIDE-MOUNT OPERATOR SENSOR FLUSHOMETER COMMERCIAL HEAVY-DUTY TOILET SEAT FRONT (NO COVER)
UR (A)	AMERICAN STANDARD WASHBROOK FLOWISE UNIVERSAL URINAL (WHITE) 6590.001.020 WHT WSHBRK URINALWASHBROOK SLOAN MANUAL FLUSHOMETERE; 3082653 186-XL REGAL FLSH VLV1.5 URINAL FLUSH VALVE WITH REGAL 186 SMO BATTERY-POWERED SIDE-MOUNT OPERATOR SENSOR FLUSHOMETER SMITH MFG. CO.; 0637.M32 URINAL CARRIER W/ BOTTOM BEARING PLATE AND 50" UPRT
EWC	ELKAY EZH20 BOTTLE FILLING STATION WITH SINGLE ADA COOLER FILTERED 8 GPH STAINLESS LZS8WSVRSK EZH20 BOTTLE KIT (1) LZS8WSVRS AND (1) LZWSR
ED	

- FD FLOOR DRAIN WITH ADJUSTABLE STRAINER HEAD SMITH MFG. CO.; 2005LXH04-A05-NB 4" FLOOR DRAIN W/5" ROUND NB TOP AND GASKET
 - WALL CLEANOUTS SMITH MFG. CO.; 4" WALL CLEANOUT

TOILET RENOVATIONS MECHANICAL SCOPE OF WORK

WCO

- MATCH COURT MEN TOILET ROOM REGISTERS.
- EXHAUST REGISTERS TO BE TITUS 350FL OR EQUAL WITH OPPOSED BLADE DAMPER. SUPPLY REGISTERS TO BE TITUS 300FL OR EQUAL WITH OPPOSED BLADE DAMPER.
- PLUMBING TO MINIMIZE FREEZING PIPES.
- INSULATE ALL PIPING LOCATED ADJACENT TO EXTERIOR WALLS TYPICAL.

ENSURE EXHAUST FAN RUNS CONSTANTLY WHILE BUILDING IS OCCUPIED

TOILET RENOVATIONS TEST AND BALANCE SCOPE OF WORK: PROVIDE TEST AND BALANCE ON SUPPLY AND EXHAUST SYSTEMS AT THE TOILET RENOVATIONS AREAS WITHIN THE SCOPE OF THIS PROJECT. TESTING, ADJUSTING, AND BALANCING AGENCY SHALL BE A MEMBER OF THE ASSOCIATED AIR BALANCE COUNCIL (AABC) OR THE NATIONAL

- ENVIRONMENTAL BALANCING BUREAU (NEBB). TESTING, ADJUSTING AND BALANCING SHALL BE PERFORMED IN ACCORDANCE WITH AABC STANDARDS.

© 2023 505 ARCHITECTS LLC



12.29.2023

ELECTRICAL PLUMBING NOTES AND SCHEDULES

CHECKED BY BT

SHEET TITLE MECHANICAL.

DRAWN BY BT

PROJECT NO 23016

12.29.2023

ISSUE DATE

ISSUE 01

73110

100 NORTH MIDWEST BLVD MIDWEST CITY, OKLAHOMA

RENOVATION

MIDWEST CITY POLICE DEPARTMENT RESTROOM



Where the Sector Processor Where the Spirit Flies Hid

/RS AND (1) LZWSR

REPLACE EXISTING CEILING SUPPLY AND EXHAUST REGISTERS WITH NEW ALL ALUMINUM CONSTRUCTION SUPPLY AND EXHAUST REGISTERS TO

AT PERIMETER WALL CHASES PROVIDE (2) 12" X 12" AIR REGISTERS IN WALL 12" BELOW CEILING TO ALLOW ROOM AIR TO CIRCULATE IN

WWW.505ARCHITECTS.COM

1631 S DELAWARE AVENUE

TULSA, OKLAHOMA 74104

918.605.5303

NUMBER ISSUE DATE

REVISION